

Jersey Shore University Medical Center

19-21 Davis Avenue Neptune, NJ 07753

Recommendation Brand Book

Created: 04/10/2024 Designer: RJW PSCO Ref: B108572

	DESIG	N SPE	CIFICATIO	NS
IBC	2021	with	NJ	amendments
ASCE	7-16	Minimum Design Loads for Buildings & Other Structures		
ACI	318-19	Building Code Requirements for Structural Concrete		
ANSI/AISC	360-16	Specification for Stuctural Steel Buildings		
	D	ESIGN	LOADS	
Wind	V =	130	mph	
Exposure	C			
Risk Cat.	III			
Grnd. Snow	Pg =	20	psf	

VERSIONSummary

e all caps.
d images.
e





SIGN INVENTORY

SITE:	HMH-002 - Jersey Shore Univ Med Ctr			
SIGN	PROPOSED SIGN			
E01	Non-Illuminated Dimensional Letters			
E02a	Non-Illuminated Dimensional Letters			
E02b	Non-Illuminated Dimensional Letters			
L				





TITLE Hackensack Meridian

DWG BY RJW

O4.10.2024

ADDRESS

HMH-002 Jersey Shore University Medical Center 19-21 Davis Avenue Neptune, NJ 07753

DWG BY RJW

DATE 04.10.2024

DATE 04.10.2024

DWG NUM
B108572

SHEET

DWG NUM
B108572

SHEET

DATE REVISION

REVISE OF E02

REVISE OF E02

REVISE ADDRESS, ADD IMAGES

REVISION

REVISE OF E02

REVISE ADDRESS, ADD IMAGES

REVISE ADDRESS, ADD IMAGES

REVISE ADDRESS, ADD IMAGES

REVISE ADDRESS, ADD IMAGES

B980

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DESIGN SPECIFICATIONS



Exposure Grnd. Snow DESIGN SPECIFICATIONS

DESIGN LOADS 130 mph

20 psf

ANSI/AISC 360-16 Specification for Stuctural Steel Buildings









108' 0"

Dr. Robert H. and Mary Ellen Harris HOPE Tower

Scale: 3/32" = 1'0"

COMMENTS.... This area is a busy valet parking area - special hours may be required for installation. A lift will be needed to remove the interior ceiling panels and access the

SCALE..... NTS

Logo Ht..... --Main Letter Ht. . . . 3' 6"

Sub Letter Ht. . . . --

SQUARE FOOTAGE 378 SF

SIGN TYPE. Custom Dimensional Letters

DIMENSIONS.... 3' 6" Cap Ht x 108' 0" OAL

DESCRIPTION. . . . Non-Illuminated Blue Aluminum Dimensional Letters

PHILADELPHIASIGN

back of the wall if required.

TITLE	Hackensack Meridian	DWG BY RJW	04.10.2024	
ADDRESS HMH-002 Jersey Shore University Medical Center 19-21 Davis Avenue Neptune, NJ 07753			B108572 SHEET 3	

04/29/24 REVISE SIZE OF E02

COLOR SCHEDULE

PMS 3005 C Medium Blue




REV 5-6-25

TOS not to exceed 32' from grade.

Dr. Robert H. and Mary Ellen Harris HOPE Tower

SIGN E -01 **BLUE DIMENSIONAL LETTERS - FRONT ELEVATION**

SCALE:1/8" = 1'-0"

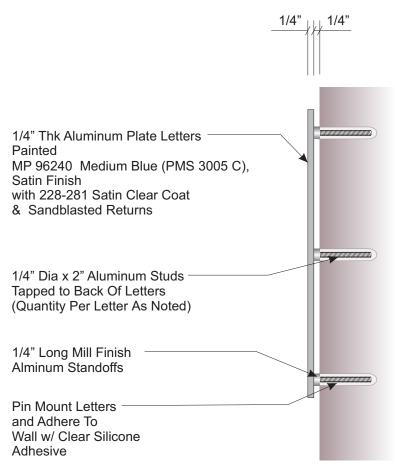

Provide Min. 1/4"Ø All Thread studs into a Min. 1-3/4" solid masonry/concrete embedment with GE SCS 2000, or equivalent, silicone adhesive, filling drill holes and coating studs immediately prior to installation as follows:

- 42" Letter I; Provide Five(5) per/letter, evenly spaced and staggered.
- 42" Letters D,R,H,M,E,O,P&T; Provide Eight(8) per/letter evenly spaced.
- Letter i; Provide Four(4) evenly spaced and staggered per/line and Three(3) per/dot.
- Remaining Letters; Provide Six(6) per/letter, evenly spaced and Three(3) per/dot.

SECTION VIEW SCALE: 3" = 1'-0"

Color Spec



Engineers Connection Note:

- All adhesives must be installed per/manufacturer's Tech Guide.
- Contact Murdoch Engineering for revision if field conditions vary.



707 West Spring Garden Street Palmyra, New Jersey 08065

Phone: 856.829.1460

CUSTOMER:

Hackensack Meridian DWG NUMBER: Health

JOB NUMBER:

B-110730

S117778 / HMH-002

SIGN TYPE:

DIMENSIONAL LTRS

LOCATION:

1945 Route 33

Neptune, NJ 07753

DATE:

9/06/24

DRAWN BY:

RVR



MANASOUAN, NJ 0873 (973) 570-8215 x0

Professional Engineer

REV 5-6-25

DESIGN SPECIFICATIONS				
IBC	2021	with	NJ	amendments
ASCE	7-16	Minimum De	sign Loads for E	Buildings & Other Structures
ACI	318-19	Building Code Requirements for Structural Concrete		
ANSI/AISC	360-16	Specification	for Stuctural St	teel Buildings
	D	ESIGN L	OADS	

Exposure Risk Cat. Grnd. Snow Pg = 20 psf

4 of 9



SIGN TYPE..... Custom Dimensional Letters

DESCRIPTION. . . . Non-Illuminated White Aluminum Dimensional Letters


DIMENSIONS. . . . 2' 10" H x 62' 5-3/4" W"

Logo Ht..... --Main Letter Ht. . . . 2' 10"

Sub Letter Ht. . . . --

SQUARE FOOTAGE 177.02 SF

COMMENTS.... --

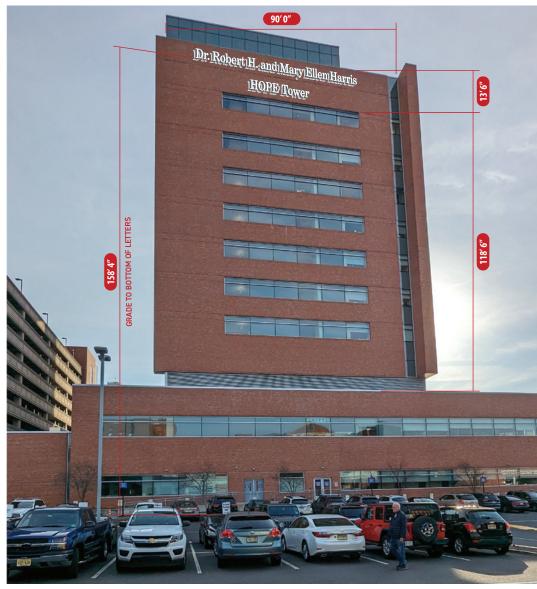

PROPOSED

Sign Rendered Proportional to Photo

62' 5-3/4"

Dr. Robert H. and Mary Ellen Harris 7.5

SCALE..... NTS

Scale: NTS

Hackensack Meridian RJW 04.10.2024 DWG NUM B108572 HMH-002 Jersey Shore University Medical Center 19-21 Davis Avenue SHEET Neptune, NJ 07753

04/29/24 REVISE ADDRESS, ADD IMAGES .


2399 NJ-34, A-2 MANASQUAN, NJ 0873

REV 5-6-25


THIS IS AN ORIGINAL LINPURLISHED. IS SUBMITTED FOR YOUR PERSONAL BEING PLANNED FOR YOURY P.S.C.O.

OUTSIDE YOUR ORGANIZATION NOR

IS IT TO BE USED, COPIED, REPRODUCED OR EXHIBITED IN ANY FASHION.

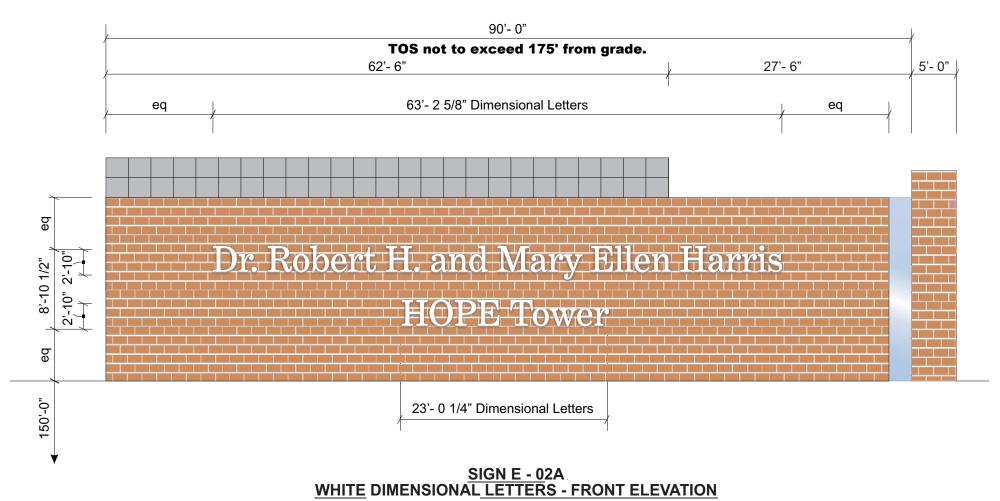

SCALE:3/32" = 1'-0"

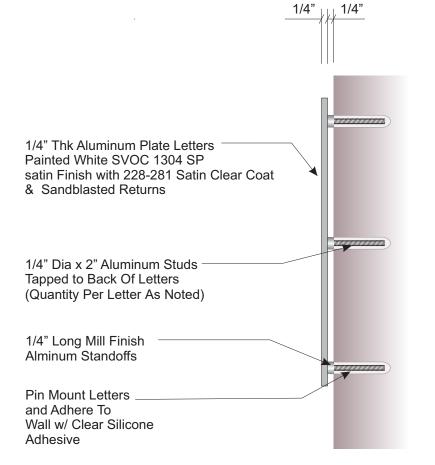

Engineers Connection Note:

Provide Min. 1/4"Ø All Thread studs into a Min. 1-3/4" solid masonry/brick embedment with GE SCS 2000, or equivalent, silicone adhesive, filling drill holes and coating studs immediately prior to installation as follows:

- 34" Letter I; Provide Four(4) per/letter, evenly spaced and staggered.
- 34" Letters D,R,H,M,E,O,P&T; Provide Six(6) per/letter evenly spaced.
- Letter i; Provide Three(3) evenly spaced and staggered per/line and Three(3) per/dot.
- Letters b,d&w; Provide Five(5) per/letter, evenly spaced.
- Remaining Letters; Provide Four(4) per/letter, evenly spaced and Three(3) per/dot.
- All adhesives must be installed per/manufacturer's Tech Guide.
- Contact Murdoch Engineering for revision if field conditions vary.

SECTION VIEW SCALE: 3" = 1'-0"



707 West Spring Garden Street Palmyra, New Jersey 08065

Phone: 856.829.1460 Fax: 856.829.8549 www.philadelphiasign.com

CUSTOMER:

Hackensack Meridian DWG NUMBER: Health

B-110730 JOB NUMBER:

S117778 / HMH-002

SIGN TYPE:

DIMENSIONAL LTRS

LOCATION:

1945 Route 33

Neptune, NJ 07753

DATE:

9/06/24

DRAWN BY:

RVR



2399 NJ-34, A-2 MANASQUAN, NJ 0873

REV 5-6-25

Professional Engineer

NJ PE Lic. #48980

DESIGN SPECIFICATIONS ACI 318-19 Building Code Requirements for Stru ANSI/AISC 360-16 Specification for Stuctural Steel Building


DESIGN LOADS

Exposure Risk Cat. Grnd. Snow Pg = 20 psf

6 of 9



EXISTING

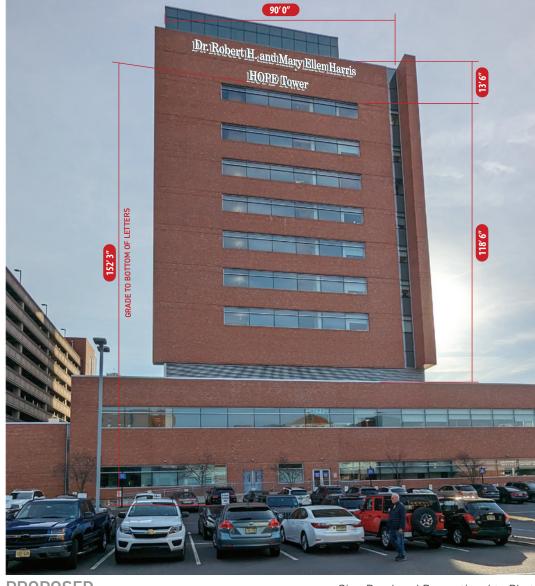

PROPOSED

Sign Rendered Proportional to Photo

SIGN TYPE..... Custom Dimensional Letters

DESCRIPTION.... Non-Illuminated White Aluminum Dimensional Letters

DIMENSIONS.... 2' 10" H x 23' 0-3/4" W

Sub Letter Ht....

SQUARE FOOTAGE 65.34 SF

COMMENTS.... --

Dr. Robert H. and Mary Ellen Harris

ETHOPE Tower

23' 0-3/4"

SCALE..... NTS

Scale: NTS

Hackensack Meridian

DWG BY RJW

O4.10.2024

DWG NUM
B108572

19-21 Davis Avenue
Neptune, NJ 07753

DATE
O4.10.2024

DWG NUM
B108572

SHEET

04/29/24 05/16/24 02/26/25

REVISION

REVISE SIZE OF E02

REVISE "HOPE" TO BE ALL CAPS

REVISE ADDRESS, ADD IMAGES

No.

48980

No.

Solvense Remains and the solv

2399 NJ-34, A-2 MANASQUAN, NJ 0873 (973) 570-8215 x0

, PE 3/19


THIS IS AN ORIGINAL LINPURLISHED.


Murdoch, PE fessional Engineer PELic #48980

REV 5-6-25

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IS SUBMITTED FOR YOUR PERSONAL
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BEING PLANNED FOR YOU BY P.S.C.O.
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OUTSIDE YOUR ORGANIZATION NOR
IS IT TO BE USED, COPIED, REPRODUCED,
OR EXHIBITED IN ANY FASHION.



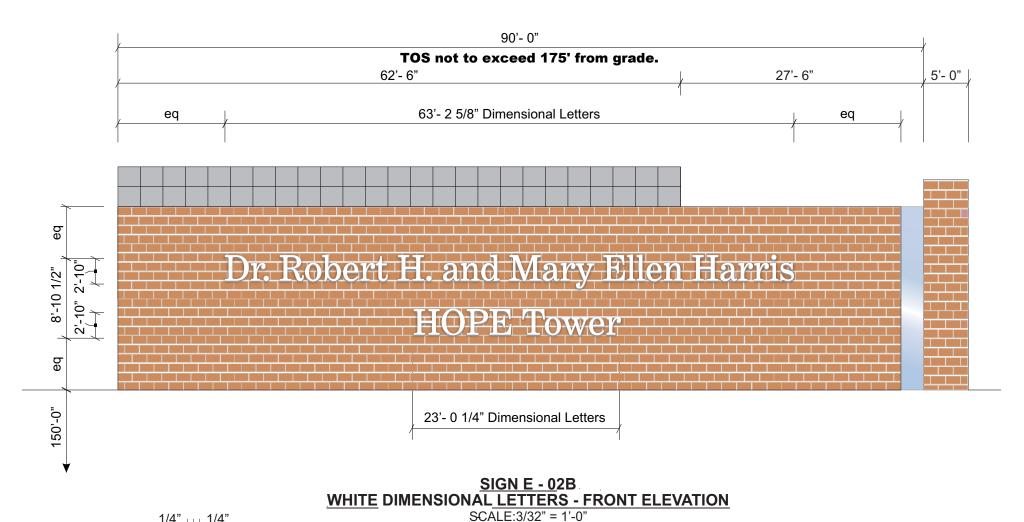

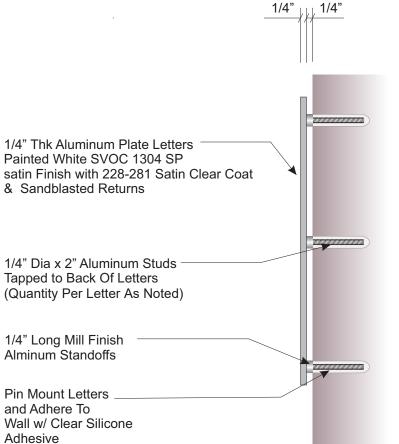


Engineers Connection Note:

Provide Min. 1/4"Ø All Thread studs into a Min. 1-3/4" solid masonry/brick embedment with GE SCS 2000, or equivalent, silicone adhesive, filling drill holes and coating studs immediately prior to installation as follows:

- 34" Letter I; Provide Four(4) per/letter, evenly spaced and staggered.
- 34" Letters D,R,H,M,E,O,P&T; Provide Six(6) per/letter evenly spaced.
- Letter i; Provide Three(3) evenly spaced and staggered per/line and Three(3) per/dot.
- Letters b,d&w; Provide Five(5) per/letter, evenly spaced.
- Remaining Letters; Provide Four(4) per/letter, evenly spaced and Three(3) per/dot.
- All adhesives must be installed per/manufacturer's Tech Guide.
- Contact Murdoch Engineering for revision if field conditions vary.

SECTION VIEW SCALE: 3" = 1'-0"

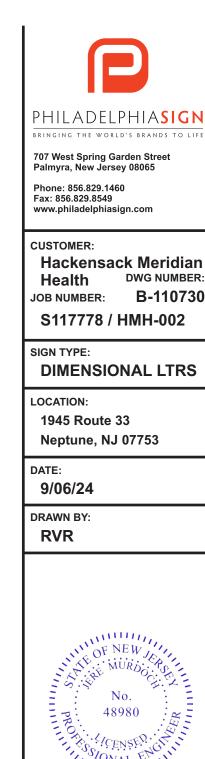

2399 NJ-34, A-2 MANASQUAN, NJ 0873 (973) 570-8215 x0

3/19/2025

DWG NUMBER:

B-110730

lere Murdoch, PE Professional Engineer NJ PE Lic. #48980

REV 5-6-25

DESIGN SPECIFICATIONS					
IBC	2021	with	NJ	amendments	
ASCE	7-16	Minimu	m Design Loads fo	Buildings & Other Structures	
ACI	318-19	Building Code Requirements for Structural Concrete			
ANSI/AISC	360-16	Specification for Stuctural Steel Buildings			
	DESIGN LOADS				
Wind	V =	130	mph		
Exposure	C				
Risk Cat.	III				
Grnd. Snow	Pg =	20	psf		

GENERAL:

- 1. ALL MATERIALS AND WORK SHALL CONFORM TO THE REQUIREMENTS OF THE APPLICABLE INTERNATIONAL BUILDING CODE (IBC).
- 2. CONSTRUCTION METHODS AND PROJECT SAFETY: DRAWINGS AND SPECIFICATIONS REPRESENT THE FINISHED STRUCTURE AND DO NOT INDICATE METHODS, PROCEDURES, OR SEQUENCE OF CONSTRUCTION. TAKE NECESSARY PRECAUTIONS TO MAINTAIN AND ENSURE THE INTEGRITY OF THE STRUCTURE DURING CONSTRUCTION. THE EOR WILL NOT ENFORCE SAFETY MEASURES OR REGULATIONS. THE CONTRACTOR SHALL DESIGN, CONSTRUCT, AND MAINTAIN ALL SAFETY DEVICES AND SHALL BE SOLELY RESPONSIBLE FOR CONFORMING TO ALL LOCAL, STATE, AND FEDERAL SAFETY AND HEALTH STANDARDS, LAWS, AND REGULATIONS.
- THE CONTRACTOR SHALL VERIFY ALL DIMENSIONS, ELEVATIONS AND SITE CONDITIONS PRIOR TO THE START
 OF CONSTRUCTION AND NOTIFY THE ENGINEER IMMEDIATELY OF ANY DISCREPANCIES OR INCONSISTENCIES
 THAT ARE FOUND. NOTED DIMENSIONS TAKE PRECEDENCE OVER SCALED DIMENSIONS. DO NOT SCALE
 DRAWINGS.
- 4. ALL OMISSIONS AND/OR CONFLICTS BETWEEN THE VARIOUS ELEMENTS OF THE WORKING DRAWINGS AND SPECIFICATIONS SHALL BE BROUGHT TO THE ATTENTION OF THE ENGINEER AND FIELD INSPECTOR. THE ENGINEER SHALL PROVIDE A SOLUTION PRIOR TO PROCEEDING WITH ANY WORK AFFECTED BY THE CONFLICT OR OMISSION.
- WHERE NO CONSTRUCTION DETAILS ARE SHOWN OR NOTED FOR ANY PART OF THE WORK, CONSTRUCT IN ACCORDANCE WITH THE STEEL CONSTRUCTION MANUAL, 14TH EDITION OR 2010 ALUMINUM DESIGN MANUAL.
- WHEN A DETAIL IS IDENTIFIED AS TYPICAL, THE CONTRACTOR IS TO APPLY THIS DETAIL IN ESTIMATING
 AND CONSTRUCTION TO EVERY LIKE CONDITION WHETHER OR NOT THE REFERENCE IS REPEATED IN EVERY
 INSTANCE.
- ANY CHANGE TO THE DESIGN AS SHOWN ON THE DRAWINGS REQUIRES PRIOR WRITTEN APPROVAL FROM DESIGN ENGINEER OF RECORD BEFORE CONSTRUCTION.
- 8. WORK PERFORMED IN CONFLICT WITH THE STRUCTURAL DRAWINGS OR APPLICABLE BUILDING CODE REQUIREMENTS SHALL BE CORRECTED AT THE EXPENSE OF THE CONTRACTOR.
- VERIFICATION: VERIFY ALL DIMENSIONS, ELEVATIONS, AND SITE CONDITIONS BEFORE STARTING WORK.
 NOTIFY THE EOR IMMEDIATELY OF ANY DISCREPANCIES.

EXISTING CONDITIONS:

- IF EXISTING CONDITIONS ARE NOT AS DETAILED IN THIS DESIGN, THE INSTALLER SHALL CEASE WORK AND NOTIFY MURDOCH ENGINEERING IMMEDIATELY.
- 2. MURDOCH ENGINEERING WILL NOT BE PERFORMING ON-SITE INSPECTIONS OR VERIFICATIONS. IT IS THE RESPONSIBILITY OF THE INSTALLER, STRUCTURE OWNER, AND PROPERTY OWNER TO IDENTIFY EXISTING CONDITIONS AND CONTACT MURDOCH ENGINEERING WITH ANY DISCREPANCIES OR CONCERNS.
- INSTALLER SHALL CONFIRM THE DIAMETER AND THICKNESS OF EXISTING MEMBERS AND NOTIFY MURDOCH ENGINEERING OF ANY DISCREPANCIES.
- 4. INSTALLER SHALL INSPECT AND CONFIRM THE QUALITY OF EXISTING STRUCTURE AS "IN GOOD REPAIR". IF THERE ARE ANY INDICATIONS THAT THIS IS NOT THE CASE, INSTALLER SHALL CEASE WORK IMMEDIATELY AND NOTIFY MURDOCH ENGINEERING.
- 5. ANY EXISTING INFORMATION SHOWN HAS BEEN FURNISHED BY THE PERSON(S) OR COMPANY THIS DOCUMENT WAS PREPARED FOR

(SEE TITLE BLOCK). MURDOCH ENGINEERING IN NO WAY CERTIFIES THIS INFORMATION AS "AS-BUILT". IF THERE IS ANY REASON TO BELIEVE THE EXISTING CONDITIONS DETAILED HEREIN ARE NOT ACCURATE, MURDOCH ENGINEERING SHALL BE NOTIFIED IMMEDIATELY.

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STEEL

1. STEEL SHAPES SHALL CONFORM TO THE FOLLOWING:

 ROUND HSS
 ASTM A500, GR B
 Fy=42 KSI MIN.

 SQUARE/RECT HSS
 ASTM A500, GR B
 Fy=46 KSI MIN.

 THREADED ROD
 F1554 GR 55
 Fy=55 KSI MIN.

 STEEL PLATE STD.
 ASTM A36 ASTM
 Fy=36 KSI MIN.

 PIPE
 A53, GR B
 Fy=35 KSI MIN.

- 2. BOLTS SHALL CONFORM TO ASTM A325 UNO.
- 3. BOLTS AND ALL THREAD ROD SHALL BE HOT-DIP GALVANIZED PER ASTM F2329 UNO.
- 4. ANCHOR BOLTS SHALL CONFORM TO ASTM F1554 UNO.
- 5. NUTS SHALL CONFORM TO ASTM A563.
- 6. WASHERS SHALL CONFORM TO ASTM F844.
- 7. STEEL HARDWARE SHALL BE HOT-DIP GALVANIZED PER ASTM A153 UNO
- 8. WELDING:
- a. WELD STRUCTURAL STEEL IN COMPLIANCE WITH ANSI/AWS D1.1 AND AISC SPECIFICATION, CHAPTER J. WELDERS SHALL BE CERTIFIED AS REQUIRED BY GOVERNING CODE AUTHORITY. WELDING SHALL BE DONE BY ELECTRIC ARC PROCESS USING LOW-HYDROGEN ELECTRODES WITH SPECIFIED TENSILE STRENGTH NOT LESS THAN 70 KSI UNLESS NOTED OTHERWISE.
- b. ALL SHOP AND FIELD WELDS SHALL BE PERFORMED BY AN AWS OR ICC CERTIFIED WELDER WITH ACTIVE STATUS AT TIME OF WELDING
- c. UNLESS A LARGER WELD SIZE IS INDICATED, PROVIDE MINIMUM SIZE WELDS PER AISC SPECIFICATION, SECTION J2, TABLE J2.4
- d. BASE PLATES SHALL BE WELDED ON TOP AND BOTTOM WITH CONTINUOUS WELDS OF AT LEAST 1/4" (IF PLATE IS CUT TO FIT TUBE INTO PLATE)

ALUMINUM:

- FABRICATE AND ERECT ALUMINUM IN COMPLIANCE WITH THE ALUMINUM ASSOCIATION (AA) 2010
 ALUMINUM DESIGN MANUAL (ADM) 1, THE SPECIFICATIONS FOR ALUMINUM SHEET METAL WORK
 (ASM35). AND IBC CHAPTER 20.
- PIPE AND TUBE SHALL BE 6061-T6 PER ASTM B241 OR B429 WITH Ftu=38 KSI MIN, Fty=35 KSI MIN, Ftuw=24 KSI MIN, Ftyw=15 KSI MIN.
- 3. STD STRUCTURAL PROFILES SHALL BE 6061-T6 PER B308 WITH Ftu=38 KSI MIN, Fty=35 KSI MIN, Ftuw=24 KSI MIN, Ftyw=15 KSI MIN.
- 4. SHEET AND PLATE SHALL BE 6061-T6 PER ASTM B209 WITH
- Ftu=42 KSI MIN, Fty=35 KSI MIN, Ftuw=24 KSI MIN, Ftyw=15 KSI MIN.
- 5. EXTRUSIONS SHALL BE 6061-T6 PER ASTM B241 OR B429 WITH Ftu=38 KSI MIN, Fty=35 KSI MIN, Ftuw=24 KSI MIN, Ftyw=15 KSI MIN.
- 6. ALL SHOP AND FIELD WELDS SHALL BE PERFORMED BY AN AWS OR ICC CERTIFIED WELDER WITH CURRENT STATUS AT TIME OF WELDING
- 7. UNLESS A LARGER WELD SIZE IS INDICATED, PROVIDE MINIMUM SIZE WELD PER ADM. ALL ALUMINUM WELDED JOINTS SHALL HAVE WELD SIZES OF AT LEAST $^1_{m 4}$ INCH
- 8. FILLET WELDS SHALL NOT EXCEED THINNEST MEMBER WALL THICKNESS JOINED.
- 9. ALUMINUM WELD FILLER SHALL BE 5356 ALLOY
- 10. WELDING PROCESS GMAW OR GTAW SHALL BE IN ACCORDANCE WITH AWS D1.2
- 11. ALUMINUM CHANNEL LETTERS SHALL BE CONSTRUCTED OF 0.090" RETURNS AND 0.125" BACKS MINIMUM, UNLESS A LARGER SIZE IS INDICATED ON DRAWINGS. THIS NOTE SHALL SUPERCEDE DRAWING DETAILS.
- 12. PROVIDE NEOPRENE GASKET BETWEEN DISSIMILAR METALS TO PREVENT GALVANIC CORROSION
- 13. ALUMINUM DIRECTLY EMBEDDED INTO CONCRETE SHALL BE CAPPED AT BOTTOM AND COATED WITH BITUMINOUS COATING OR POLYURETHANE WHERE IN CONTACT WITH CONCRETE.
- 14. FASTENERS BETWEEN DISSIMILAR METALS SHALL BE STAINLESS STEEL 316.

SCOPE OF WORK:

LIMITS OF LIABILITY TO EXTEND ONLY TO THE QUANTITY INDICATED. ATTEMPTS IN PART
OR IN WHOLE TO INSTALL GREATER QUANTITIES THAN THOSE SPECIFIED WITHOUT
CONSULTING MURDOCH ENGINEERING SHALL VOID ALL PROFESSIONAL LIABILITY
AND COVERAGE. ENGINEERING LIABILITY IS LIMITED TO BUILDING CONNECTIONS.



murdochengineering.com (973) 570-8215 2399 NJ-34 A-2 Manasquan, NJ 08736


PHILADELPHIASIGN
BRINGING THE WORLD'S BRANDS TO LIFE

Hackensack Meridian Health

PROJECT ADDRESS:

PROJECT TITLE:

1945 Route 33 Neptune, NJ 07753

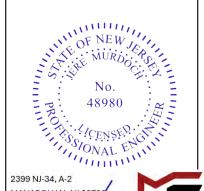

2399 NJ-34, A-2 MANASQUAN, NJ 0873 (973) 570-8215 x0

WE Lic. #48980

lere Murdoch, PE
Professional Engineer

REV 5-6-25

BESIGN SPECIFICATIONS

IBC 2021 with NJ amendments

ASCE 7-16 Minimum Design Loads for Buildings & Other Structures

ACI 318-19 Building Code Requirements for Structural Concrete

ANSI/AISC 360-16 specification for Structural Steel Buildings