General Notes

- DIMENSIONS IN THE FIELD AND INFORM THE ARCHITECT OF ANY CONDITIONS WHICH WOULD PREVENT INSTALLATION OF WORK IN ACCORDANCE WITH THE CONTRACT DOCUMENTS.
- 2. THE CONTRACTOR SHALL AT NO ADDITIONAL COST TO THE OWNER OBTAIN ALL REQUIRED PERMITS AND ARRANGE FOR ALL OF THE INSPECTIONS REQUIRED BY THE LOCAL DEPARTMENT OF BUILDINGS.
- 3. ALL WORK TO BE FILED UNDER AND SHALL CONFORM WITH ALL APPLICABLE CODES AND REQUIREMENTS.
- 4. THE CONTRACTOR SHALL SCHEDULE AND COORDINATE THE WORK OF ALL TRADES AND BE RESPONSIBLE FOR BOTH DAILY AND OVERALL PROJECT SITE CLEAN-UP AT THE CONCLUSION OF WORK.
- SHOULD THERE BE ANY CONFLICT BETWEEN WHAT IS SHOWN ON THE CONSTRUCTION DRAWINGS SPECIFICATIONS, THE CONTRACTOR SHALL BRING SUCH CONFLICT TO THE ATTENTION TO THE ARCHITECT FOR RESOLUTION.
- CONTRACT DOCUMENTS INDICATE TYPE OF DESIGN AND GENERAL CONSTRUCTION AND ARE INTENDED TO IMPLY THE FINEST QUALITY OF CONSTRUCTION MATERIALS AND THE WORKMANSHIP THROUGHOUT.
- 7. THE CONTRACTOR SHALL MAINTAIN ON-SITE A CURRENT AND COMPLETE SET OF CONTRACT DOCUMENTS AS APPROVED BY THE LOCAL BUILDING DEPARTMENT DURING ALL PHASES OF WORK FOR USE BYALL TRADES AND REFERENCE. ALL OUT OF DATE DRAWINGS SHALL BE REMOVED FROM THE JOB SITE.
- UPON ACCEPTANCE OF THE CONTRACT DOCUMENTS, THE CONTRACTOR ASSUMES FULL RESPONSIBILITY FOR THE VARIOUS CONSTRUCTION MATERIALS AND WORKMANSHIP OF THE SCOPE OF WORK DESCRIBED IN THOSE DOCUMENTS AND WILL EXECUTE THE WORK TO COMPLY WITH THE SPIRIT IN WHICH THEY WERE PRODUCED.
- 9. OWNER SHALL ONLY SUPPLY ACCESS TO THE SITE, A SUPPLY OF CLEAN AND POTABLE WATER AND AN 110V AC SOURCE OF ELECTRICITY FOR SMALL HAND HELD POWER TOOLS.

Special Notes

INDEMNIFICATION CLAUSE: THE OWNER SHALL RELEASE, HOLD HARMLESS AND INDEMNIFY THE ARCHITECT WITH RESPECT TO ANY CHANGES MADE TO THE CONSTRUCTION DOCUMENTS BY ANYONE OTHER THAN THE ARCHITECT, OR CHANGES IN ANY ASPECT OF THE WORK, OR FAILURE BY THE CONTRACTOR TO BUILD IN ACCORDANCE WITH THESE CONSTRUCTION DOCUMENTS.

PERMITS AND RELATED FEES: CONTRACTOR TO PROCURE ALL REQUIRED CONSTRUCTION PERMITS AS PART OF THE SCOPE OF WORK. OWNER TO PAY ALL PERMIT AND REQUIRED SURVEY COSTS.

NOTICE OF COPYRIGHT: USE OF THESE CONSTRUCTION DRAWINGS RE LIMITED TO THE PROJECT SITE ALL OPYRIGHT INTENDED. REPRODUCTION IS RESERVED BY THE ARCHITECT - MARK ALEXANER PAVLIV, AIA OF RECORD. ARCHITECT REPRODUCTION AND USE OF THESE


DOCUMENTS OR ANY PART THEREOF

WITHOUT THE EXPRESSED WRITTEN

AUTHORIZATION AND CONSENT OF THE

ARCHITECT IS STRICTLY PROHIBITED.

THE CONTRACTOR SHALL VERIFY ALL

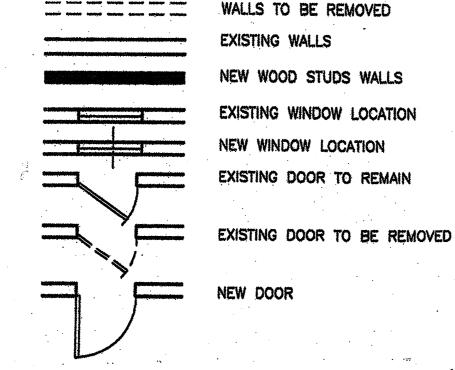

Legend

	, · · · · · · · · · · · · · · · · · · ·
	STRUCTURAL BEAM
	JOIST FRAMING
	ROOF OVERHANG OR SOFFIT LINE
₩	ELEC. WALL SWITCH
↔D	ELEC. WALL DIMMER
↔ 3	ELEC, 3 WAY SWITCH
+	ELEC. WALL OUTLET
:	ELEC. FLOOR OUTLET
-	ELEC. HALF-HOT WALL OUTLET
+	CEILING MOUNTED LIGHT
-ф 1	BRACKET/WALL MOUNTED LIGHT
Φ-	RECESSED CEILING LIGHT
\$ -	RECESSED DIRECTIONAL LIGHT
S	EXHAUST FAN/HEAT LAMP
0	SMOKE DETECTOR
Δ	TV/CABLE JACK
A .	TELEPHONE JACK

FLOOR AREA CALCULATIONS:			
	EXISTING	PROPOSED	PERMITTED
First Floor:	799.2 sf	1,230.5 sf	
Second Floor:	649.2 sf	1,230.5 sf	
Habitable Attic	: 249.0 sf	407.0 sf	
Total Area:	1,697.4 sf	2,868.0 sf	N/A
Covered Front Porch	354.0 sf	354.0 sf Same	N/A
Covered Rear Porch	26.7 sf	154.3 sf	N/A

DUAL FLOOD/MOTION LIGHT

TOTAL PROPOS	ED VOLUMI	E of ADDITION
First Floor:	4,468.7 cf	7
Second Floor: Habitable Attic:	3,970.4 cf 1,336.0 cf	} _
Total Volume:	9,775.1 cf	1/2

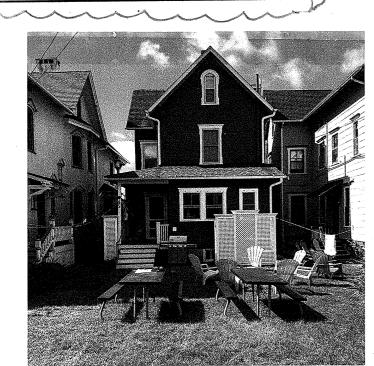


Photo Reference

Area Calculations

Terrie O'Connor Applicant:

7 Ocean Pathway Ocean Grove, New Jersey 07756

Site Address: 7 Ocean Pathway, Ocean Grove, NJ 07756 **Block #115, Lot #6; ZONE: HD-O**

<u>Description</u>: Proposed Rear Addition and Various Renovations to the existing 2 ½ story wood frame single-family landmark dwelling located at 7 Ocean Pathway, Ocean Grove, New Jersey.

LOT SIZE	EXISTING	PROPOSED	REQUIRED
Frontage	30.15 ft	no change	30.0 ft
Lot Width	30.10 ft	no change	30.0 ft
Depth	84.04 ft	no change	60.0 ft
Depth	perty Line from Flare) 80.60 ft perty Line from Flare)	no change	60.0 ft
Area	2,481.95 sf	no change	1,800 sf

4,190.85 SI*	
(*Se	ction 413.06.E)
ACK	EXISTING

SETBACK	EXISTING	PROPOSED	ALLOWED
Front	9.61 ft	Same	Section 413.06.D
(to edge of dwellin	g)		1
Front	0.43 ft	Same	Section 413.06.D
(to edge of covered			
East Side	6.21 ft	Same	2.0 ft
(to edge of dwelling	O /	C	
East Side	4.21 ft	Same	2.0 ft
(to edge of dwelling East Side	0.82 ft	Cama	3 0 6
(to edge of existing	·· -	Same	2.0 ft
East Side	- 0.45 ft (over)	Same	204
	covered porch roof ov		2.0 ft
(8 3)	covered poren rooj ov	crnangj	
East Side	N/A	6.21 ft	2.0 ft
	ed rear dwelling additio	on)	
East Side	N/A	5.21 ft	2.0 ft
	ed rear addition roof or		
East Side	N/A	6.21 ft	2.0 ft
(to edge of propose	• /	4.04.0	
East Side	N/A	4.21 ft	2.0 ft
(to eage of propose	ed covered porch roof o	overhang fascia)	
West Side	2.45 ft	Same	2.0 ft
(to edge of existing	0/	~	
West Side	0.95 ft	Same	2.0 ft
	dwelling roof overhan		• • •
West Side		Same	2.0 ft
(to edge of existing West Side	0.95 ft	C	2.0.6
	covered porch roof over	Same	2.0 ft
(to eage of existing	covereu porch rooj ovi	ernang)	
West Side	N/A	2.51 ft	2.0 ft
	d rear dwelling additio	n)	
West Side	N/A	2.01 ft	2.0 ft
	d rear addition roof ov		
West Side	N/A	2.51 ft	2.0 ft
(to edge of proposed	* /	• • • •	
West Side	N/A	2.01 ft	2.0 ft
(10 eage of proposed	d covered porch roof o	verhang fascia)	
Rear	29.97 ft	An on A	Section 413.06.D
	d dwelling addition at	Bath Avenue Flare	Section 413,00.D
Rear	28.47 ft	3.30 ft 2	Section 413.06.D
	d rear porch steps at B		Section 413,00.D
Floor Levels	2.5 stories	2.5 stories	2.5 stories
Usight	20 5 C	2.5 Stulies	2.5 stories

Height 32.5 ft **LOT COVERAGE:**

20.0 sf

35.0 sf

183.0 sf

N/A

24.0 sf

(1,480.7 sf)

Building Cover: 1,179.7 sf

Front/Side Steps: 19.0 sf

(includes covered porch areas)

Rear Steps:

Rear Porch:

Walkways:


AC Units:

Outdoor Rinse:

Total Cover



21.0 sf

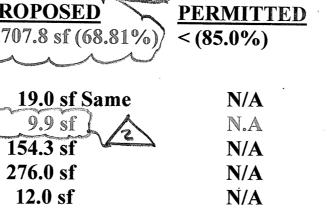


N/A

35.0 ft

*(Section 413.06.E)

Survey, dated April 20, 2017, has been prepared by Michael Williams, PLS, 56 Main Street, Ocean Grove, New Jersey, a licensed New Jersey Land Surveyor.

 $(2,193.8 \text{ sf } (52.36\%)^{*}) < (90.0\%)$

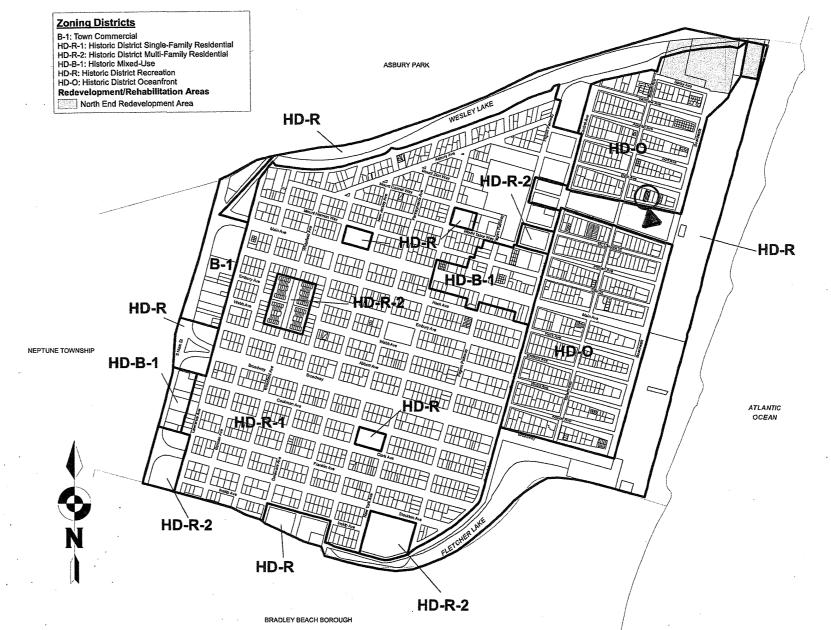

BATH

Concrete

Iron Pipe Fence

S 60° 51' 25" E

(LOT 469)

ONE STORY

2 1/2 STORY

DWELLING

COVERED PORCH

730 155' □

OCEAN

Roof Gutter — Along Line

FRAME

BLOCK 115

FRAME

FRAME

GARAGE

(LOT 467)

LOT 5-

(LOT 466)

2 1/2 STORY

DWELLING

NO. 9

COVERED PORCH

120.62

Site Survey Reference Plan

Iron Stake Set —

Iron Pipe Fd.

Location Map

Scale: Graphic Scale

VEN

00円

Monument Found

List of Drawings A-1 General Notes, Zoning & Area Calculations & Site Survey Reference

A-2 Elevations

A-3 Foundation & Site Plan A-4 First & Second Floor Plans

A-5 Attic, Roof, Plumb Riser

A-6 Typical Construction Section & Details

A-7 Interior Door, Window & Finish Schedules

A-8 Specifications

A-9 REScheck **Energy Compliance**

E-1 First & Second Floor **Electrical Floor Plans**

E-2 Attic Level Electrical Plans & Specifications

Sidewalk

AVENUE

PORCH

(LOT 470)

LOT 7

2 1/2 STORY

FRAME

DWELLING

NO.5

COVERED PORCH

PATHWAY

77 Main Avenue, Suite 101 Ocean Grove, NJ 07756 (732) 776 - 8777NJ Lic No. AI00820300 springlakearchitect.com mp77aia@aol.com

> **Proposed Renovations** & Rear Addition to the Existing 2 1/2 Story **Wood Frame Single-Family Dwelling** Block #115, Lot #6

Use Group: R5 **Construction Type: 5B**

PROJECT NAME 7 Ocean Pathway Ocean Grove, NJ

DRAWING TITLE General Notes, **Survey Reference**

As Noted 2022990075 DRAWN BY

ISSUES Description Date . 20MING COMMENT 2 HPC COMMENTS Mark Alexander Pavliv, AIA

REVISIONS

ZONING COMMENTS 3/21/22

Date


Description

2 HPC COMMENTS

No.

O'Connor Residence **Area Calculations** JOB No.

CHECKED BY

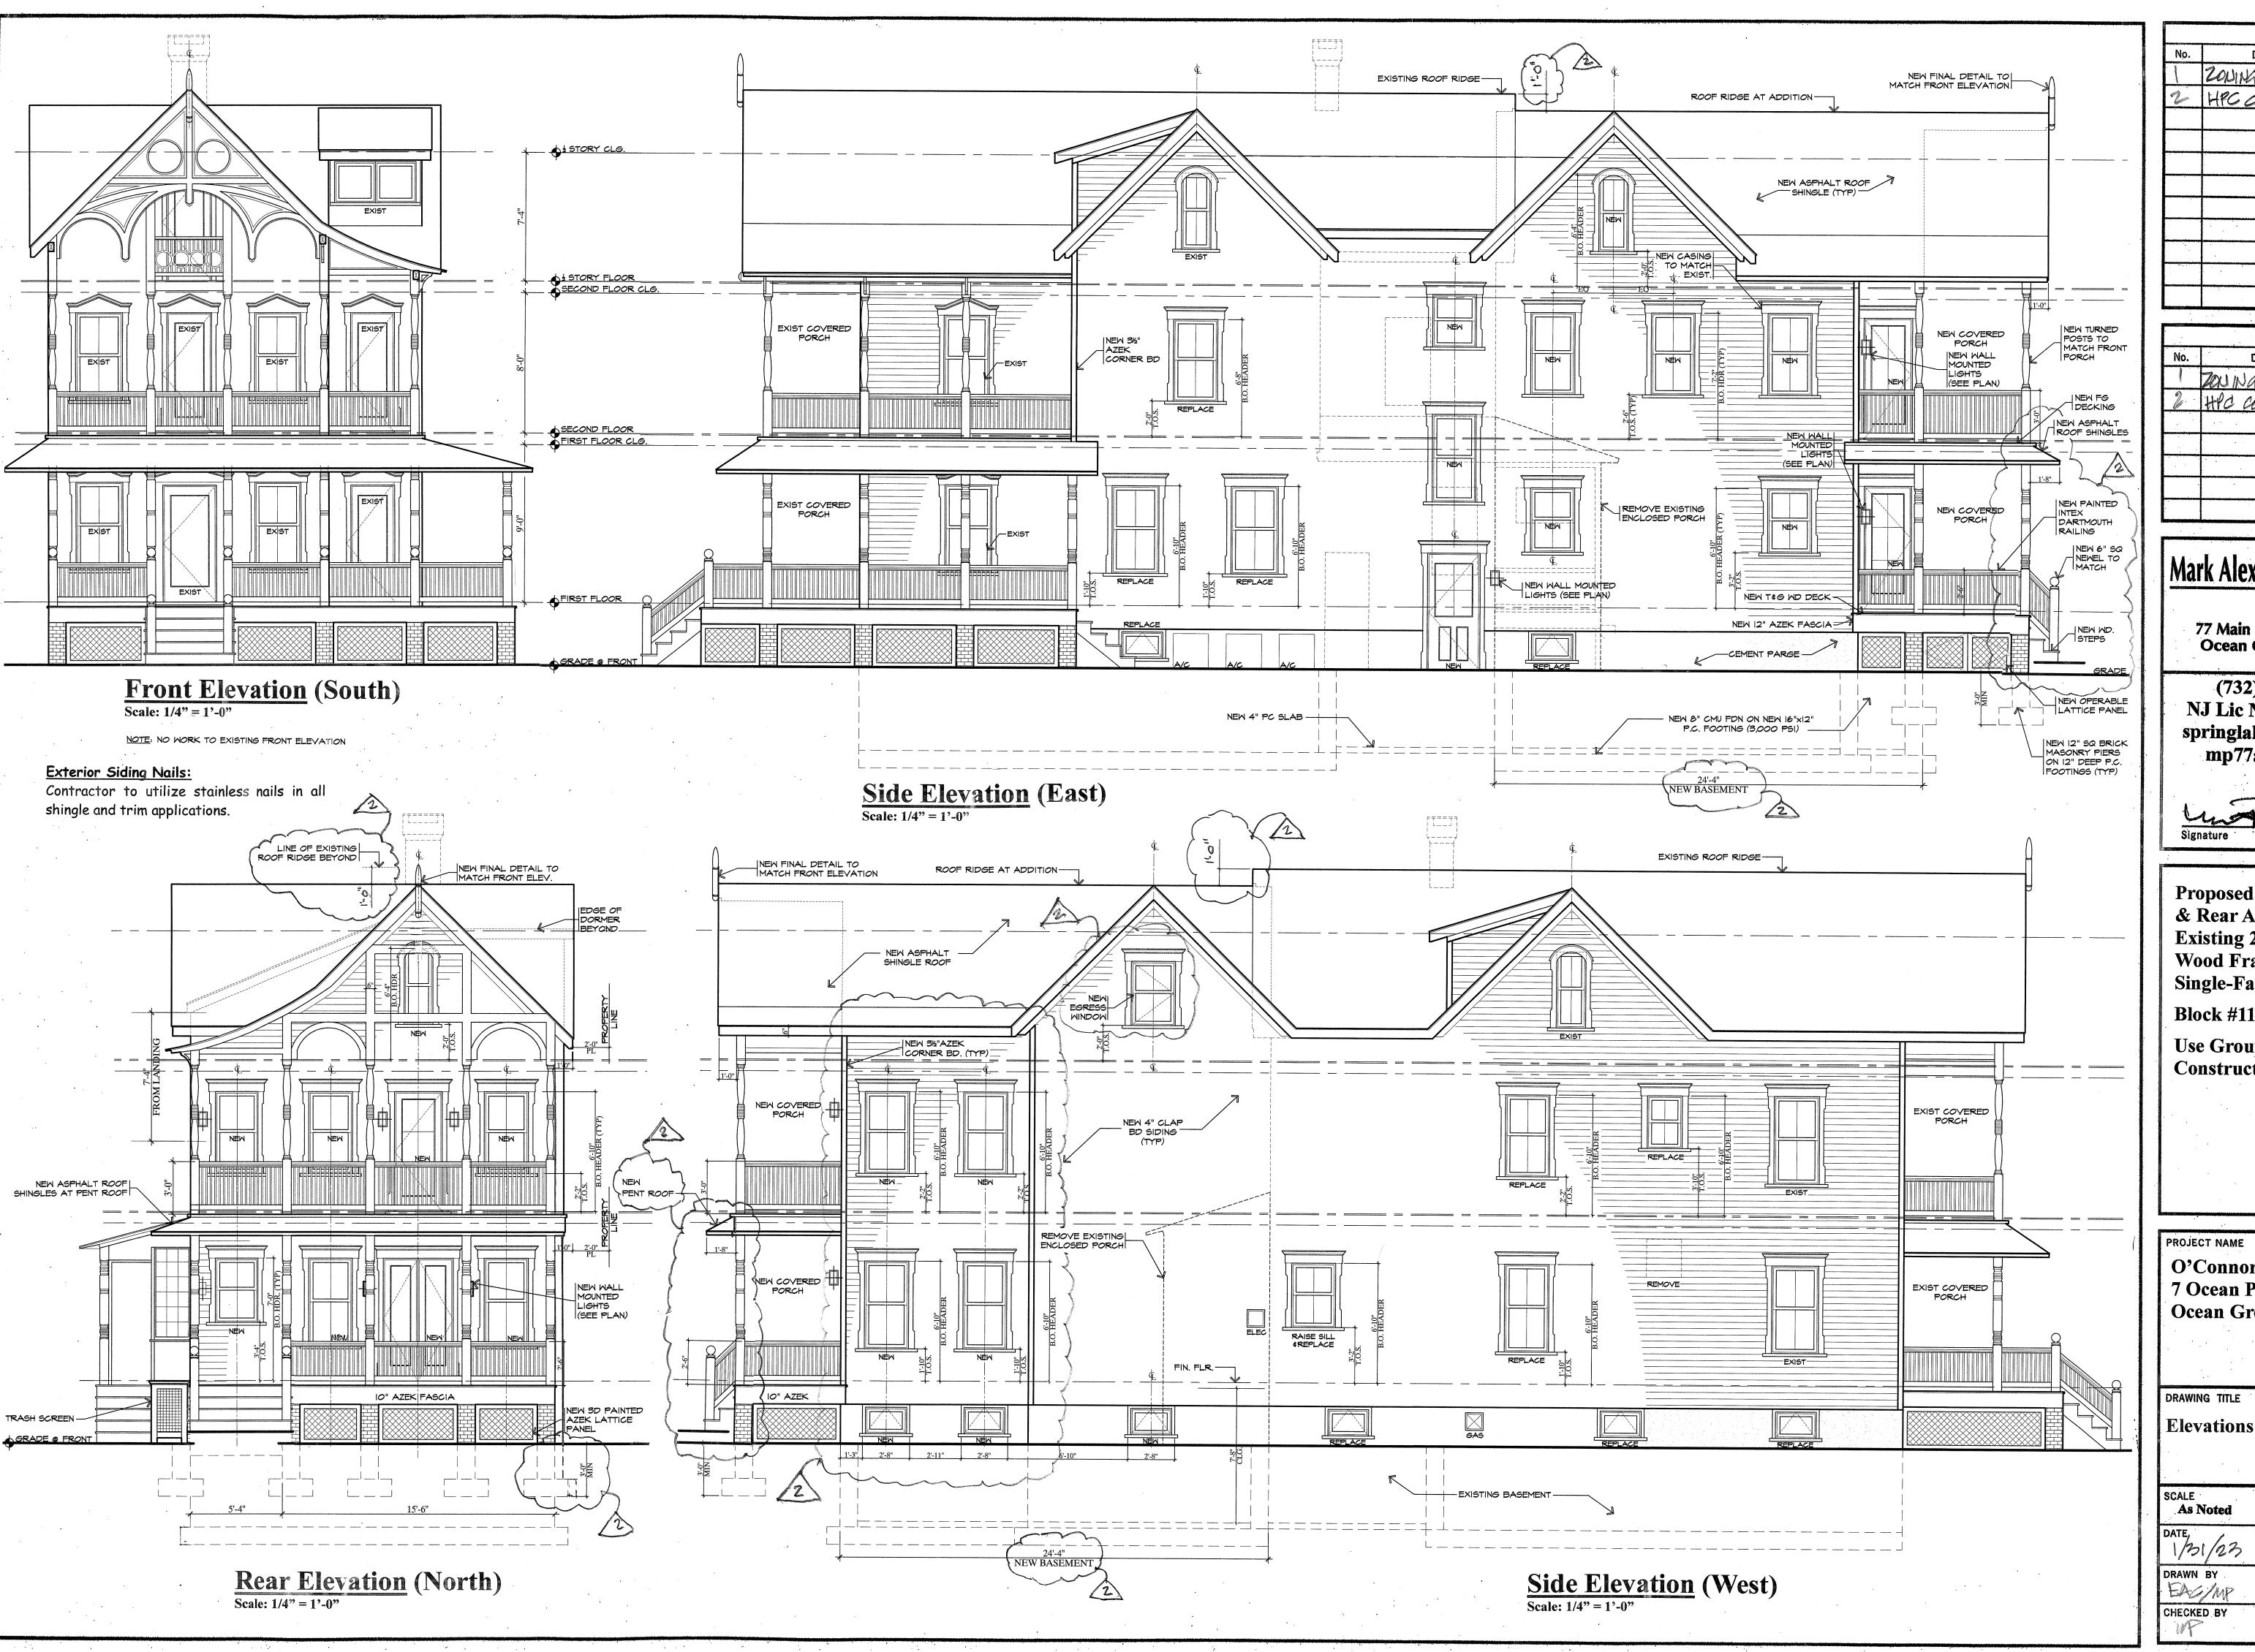

	REVISIONS		
No.	Description	Date	
1	ZOUING COMMENTS	3/21/23	
2	HPC COMMENTS	6/12/22	
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ISSUES			
No.	Description	Qate	
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2	ZOUING GOMMENTS HPC COMMENTS	6/12/23	

Mark Alexander Pavliv, AIA

77 Main Avenue, Suite 101 Ocean Grove, NJ 07756


(732) 776 – 8777
NJ Lic No. AI00820300
springlakearchitect.com
mp77aia@aol.com




Proposed Renovations & Rear Addition to the Existing 2 1/2 Story Wood Frame Single-Family Dwelling Block #115, Lot #6
Use Group: R5
Construction Type: 5B

O'Connor Residence 7 Ocean Pathway Ocean Grove, NJ

SCALE As Noted	JOB No. 2022990075
DATE, 1/31/23	DRAWING No.
DRAWN BY	A2

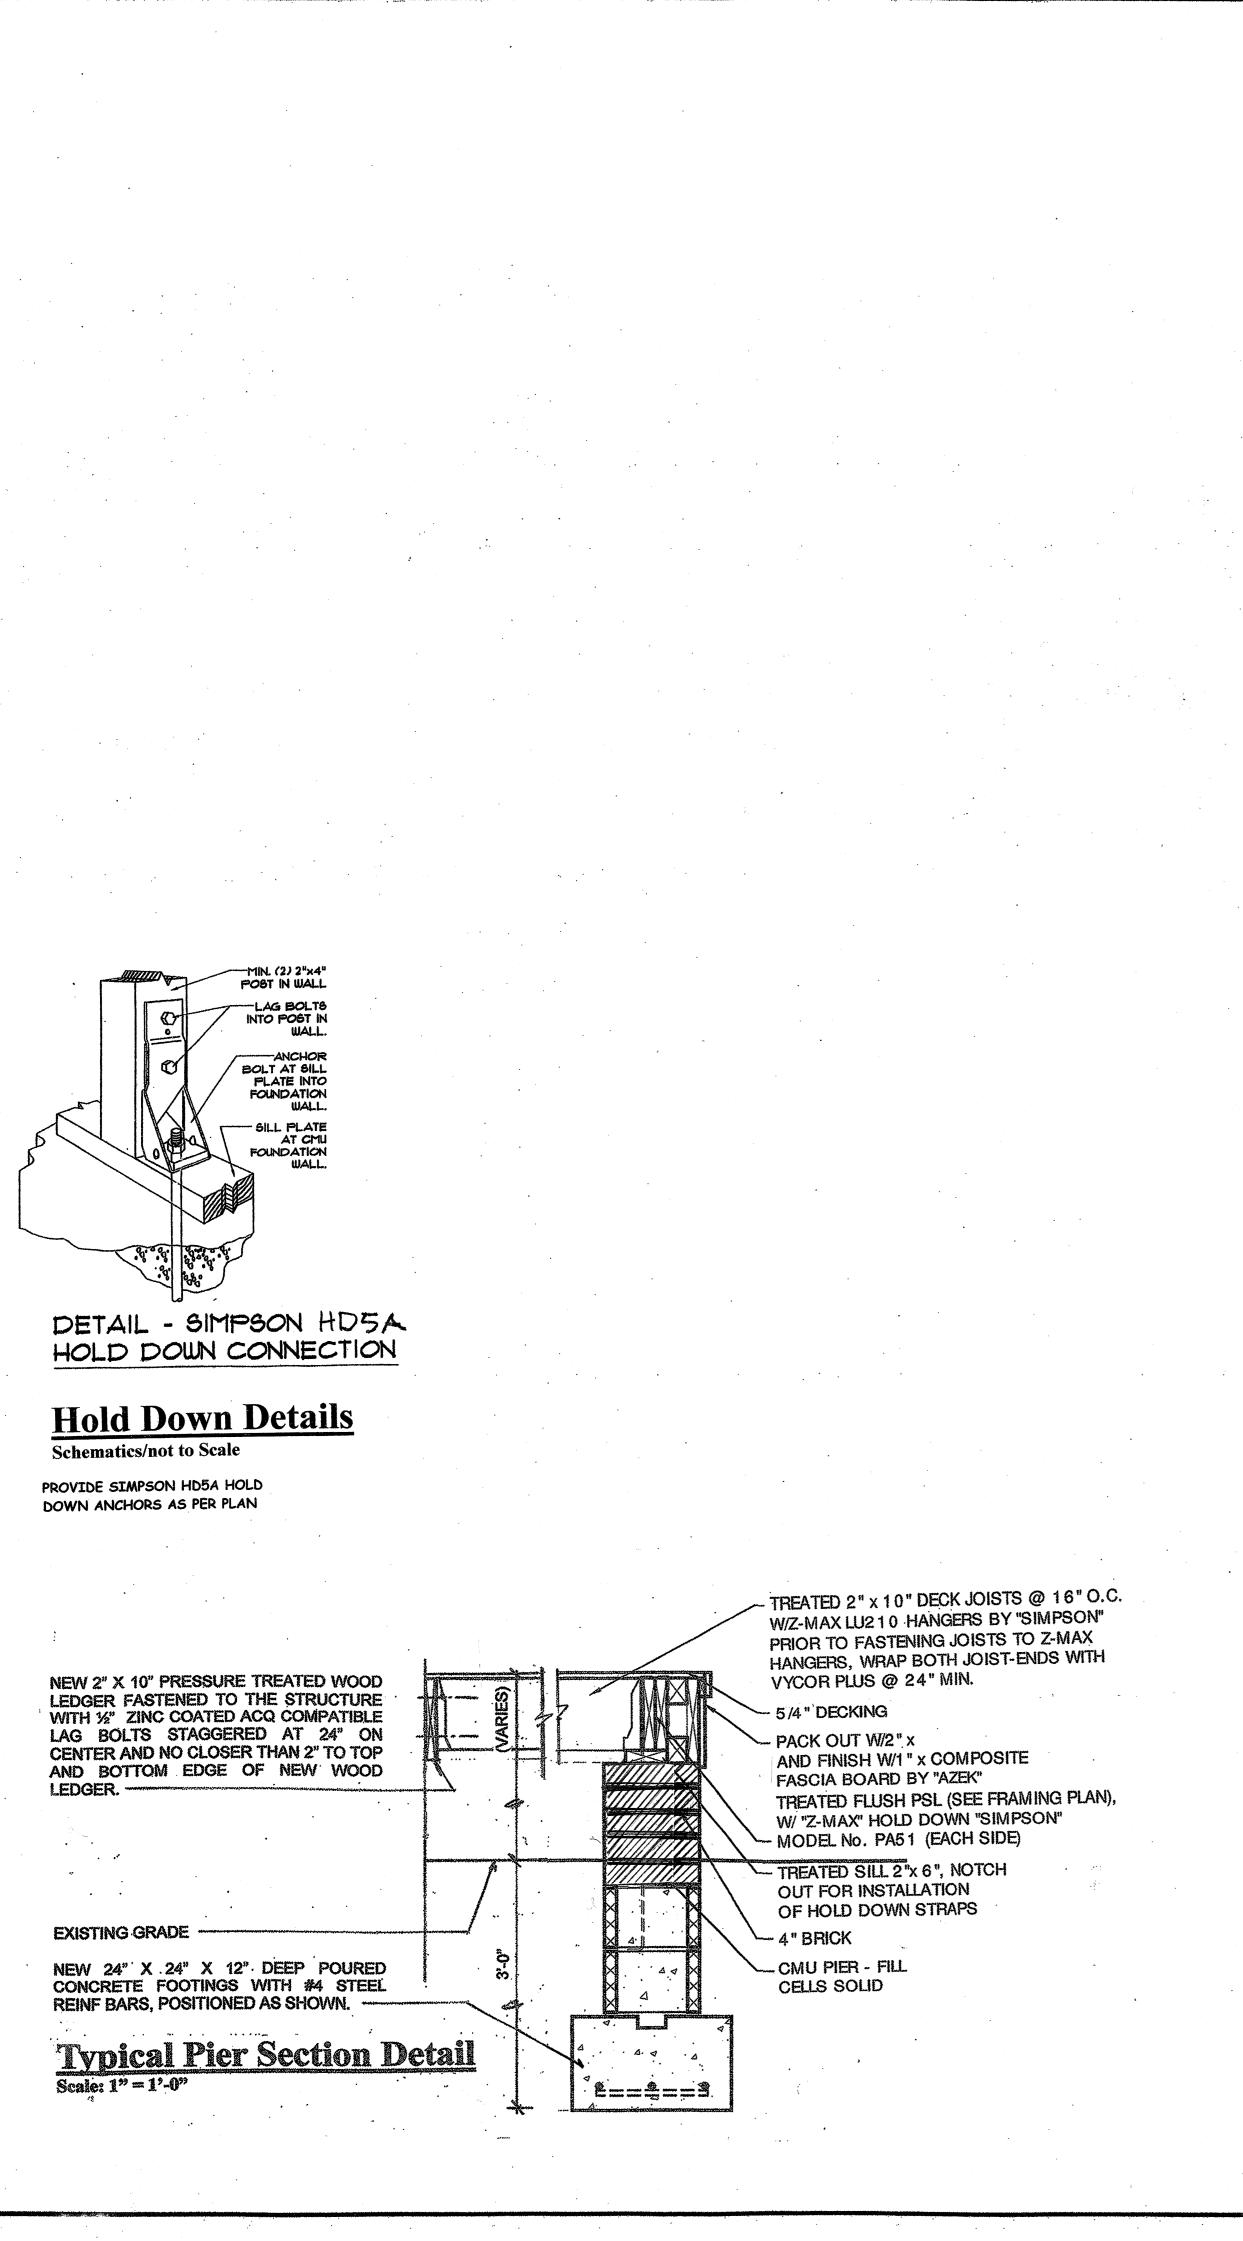

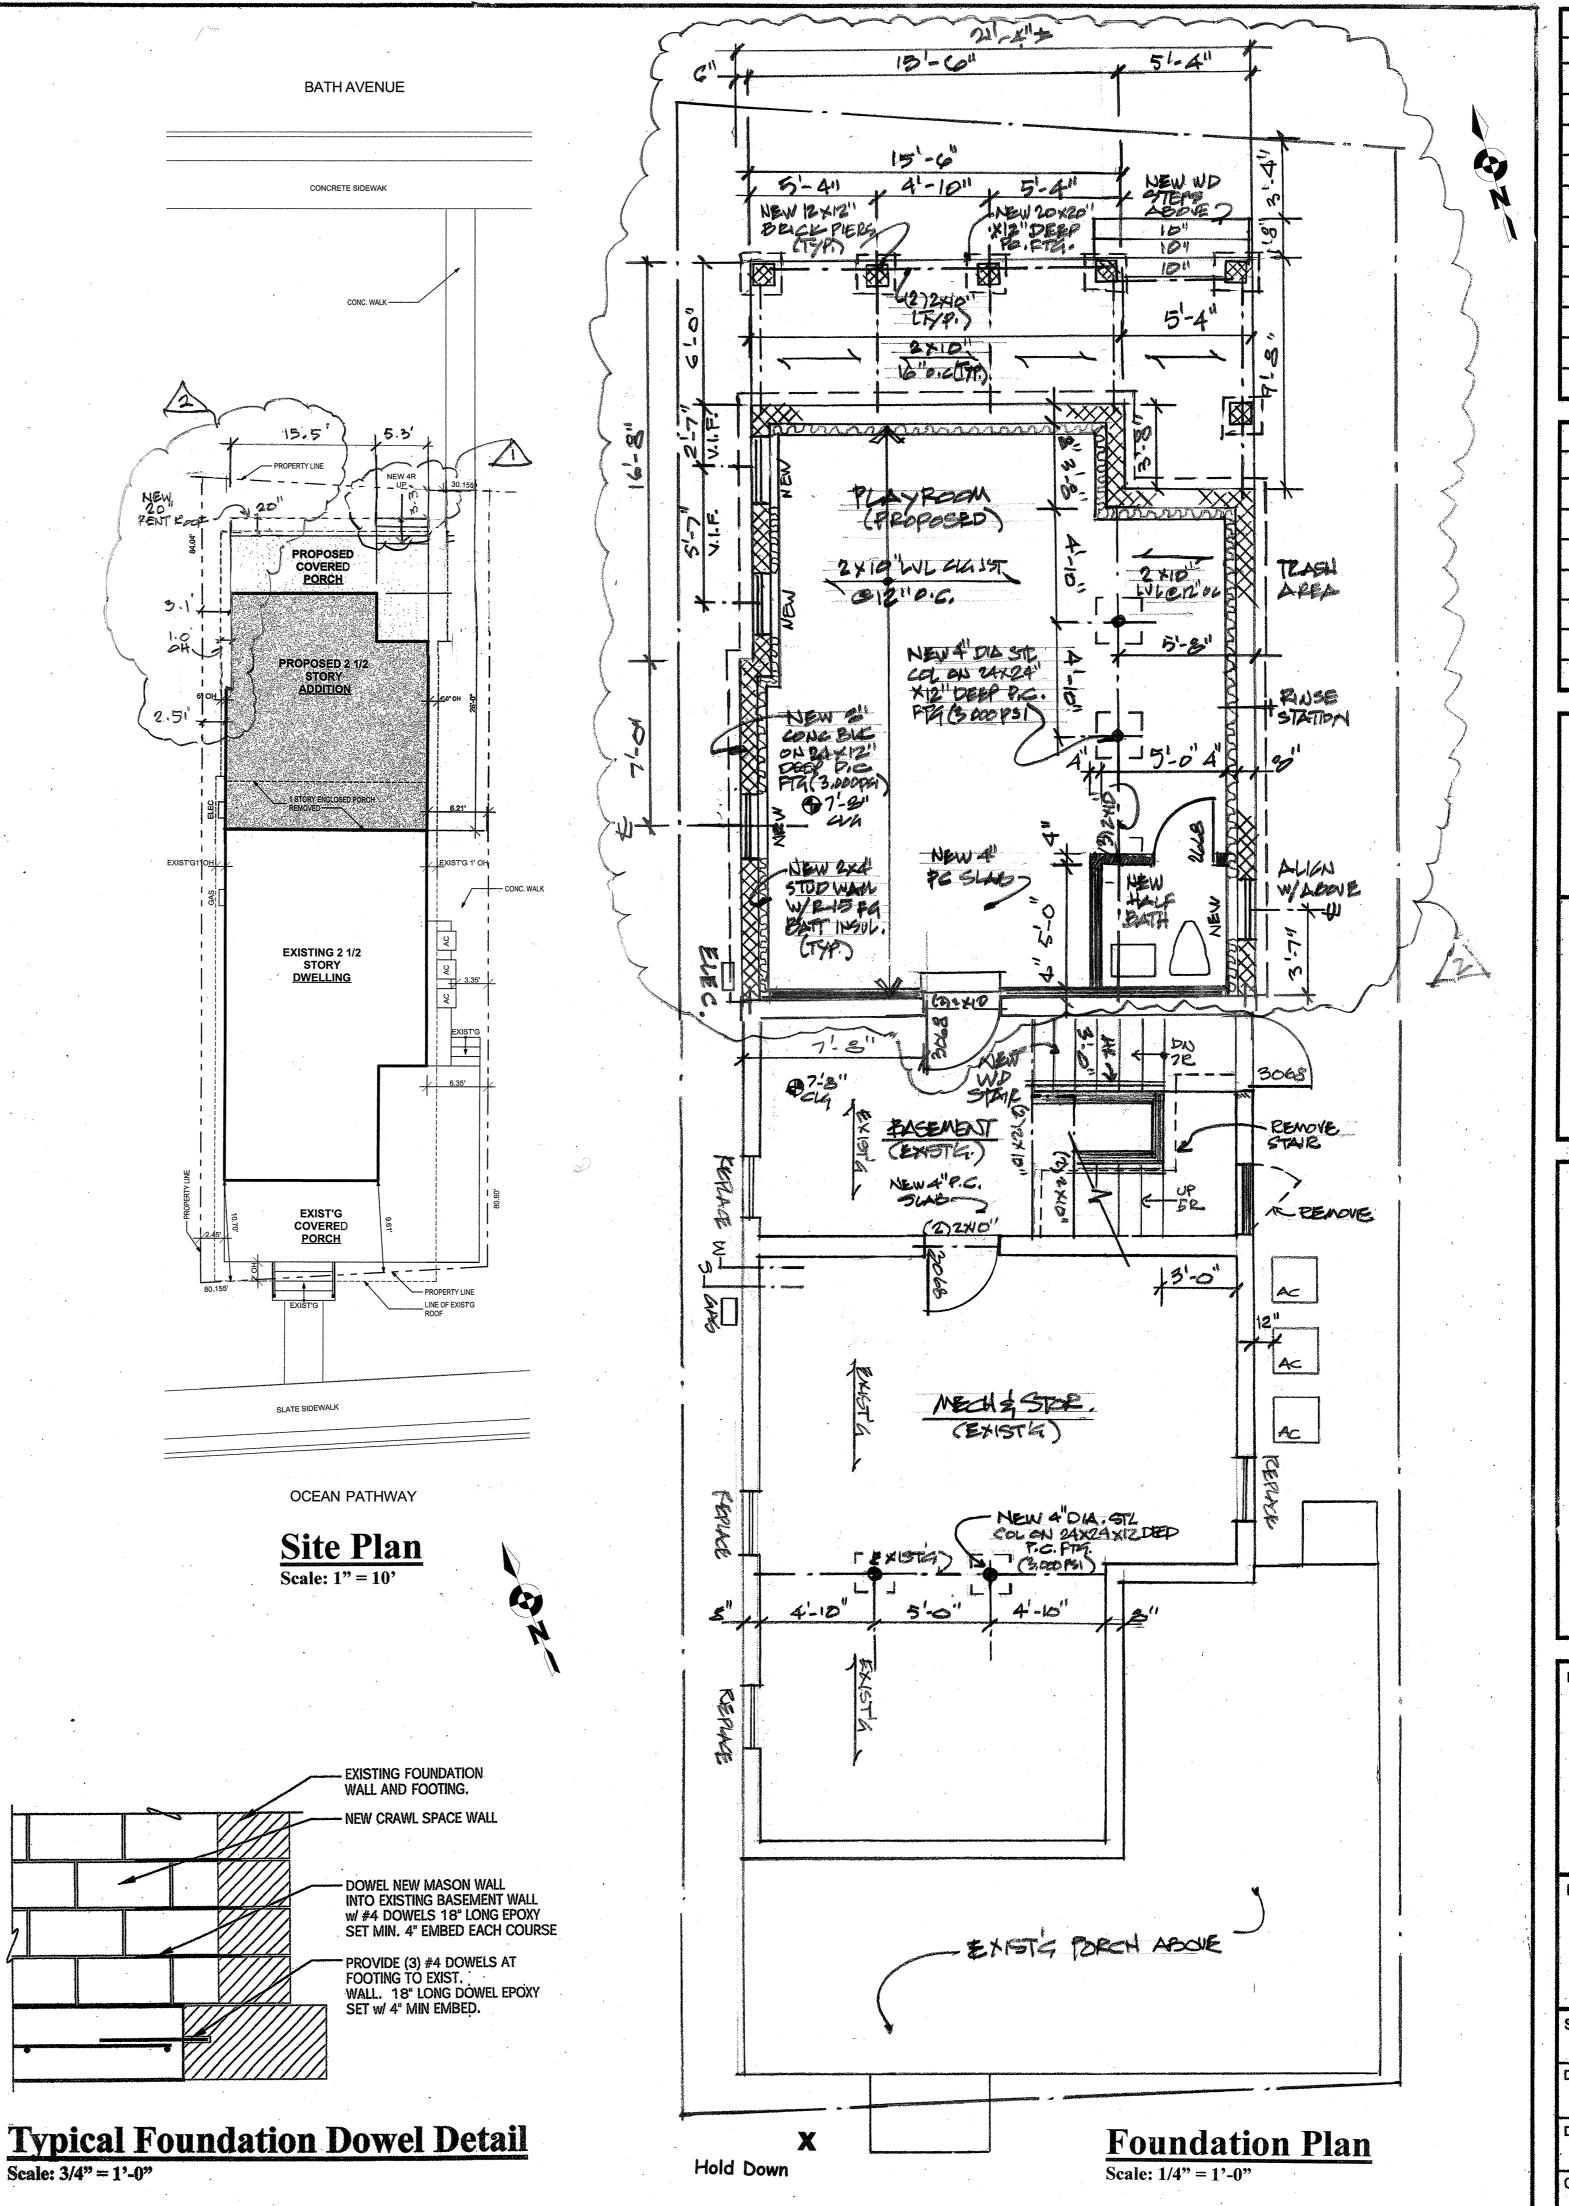


THE PERSON NAMED IN			
*		REVISIONS	
	No.	Description	Date
		ZONING COMENTS	3/2/23
	2	ZONING COMMENTS	6/2/23
)			

ISSUES			
No.	Description	Date	
	ZONING COMPASS	3/21/23	
2	HPC COMMENTS	6/12/23	

Mark Alexander Pavliv, AIA

77 Main Avenue, Suite 101 Ocean Grove, NJ 07756

(732) 776 - 8777NJ Lic No. AI00820300 springlakearchitect.com mp77aia@aol.com

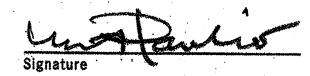

Proposed Renovations & Rear Addition to the **Existing 2 1/2 Story Wood Frame Single-Family Dwelling** Block #115, Lot #6 **Use Group: R5 Construction Type: 5B**

PROJECT NAME O'Connor Residence 7 Ocean Pathway Ocean Grove, NJ

DRAWING TITLE

Foundation &Site Plan

SCALE As Noted	JOB No. 2022990078
DATE 1/31/23	DRAWING No.
DRAWN BY	A3

CAN / SAL/M CHECKED BY

Special Notes:

All proposed work to comply with the 2021 International Residential Code New Jersey Edition

Exterior siding, roofing and windows shall be rated and installed as per manufacturer's recommendations so as to withstand 120 mph winds.

Contractor to provide hurricane/wind rafter tie downs and structural hold downs in accordance with details and all fasteners in accordance with R802.11 and specified on Typical Section Detail.

Contractor to utilize wall bracing panel construction method R602.10.3 which states that "Wood structural panel sheathing with a thickness not less than 5/16" shall be used for 16" stud spacing" and all structural panels shall be installed in accordance with Table R602.3 as provided in the Construction Documents or otherwise required by the Wood Construction Manual ANSI/AF&PA WFCM-2001 Edition.

All sheathing to utilize the 6 and 12 method in which all perimeter sheathing is to be nailed with 8d nails at 6 inch on center in staggered fashion at sheathing edges and joining seams and at 12 inch on center along exterior stud spacing.


COUNTER -


Controlled Roof Drainage to be maintained via a gutter and leader system which must collect and discharge roof water to the ground surface to a minimum distance of 5 feet from the foundation wall onto permeable soil so as to recharge the site.

Carbon Monoxide Alarms are required within the immediate vicinity of all bedrooms or identified sleeping areas.


Contractor to verify acceptability of all egress window sizes in accordance with

Smoke and Carbon Monoxide Detection: Provide interconnected 110v smoke detector in accordance with IRC 2021 New Jersey Edition - as indicated on all floor plans. Smoke and Carbon Monoxide detection devices to be provided within vicinity of each sleeping area and no further than 10 feet from outside (entry door) of each bedroom.

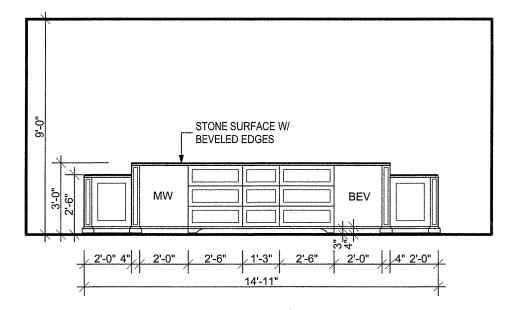

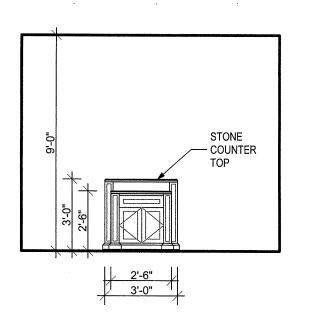

2'-6"

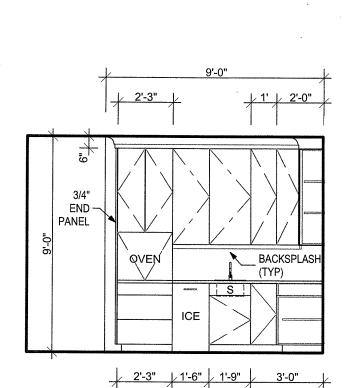

View to South

Kitchen Elevations Scale: 1/4" = 1'-0"

PROVIDE FIBERGLASS BATT INSULATION (R-15) IN ALL EXISTING EXPOSED STUD EXTERIOR WALL AREAS (TYP) WHERE INSUL IS MISSING OF DEFICIENT,

NEW CLOSED CELL (R-21) IN ALL NEW CONSTRUCTION EXTERIOR STUD CAVITIES.

RAISE SILL & REPLACE EXISTING MINDOM

REMOVE & REPLACE EXISTING WINDOW

NEW 10" WOOD TREADS NEW TURNED 6" POST TO MATCH NEW (3)2"xIO" O NEW BEADED BD SOFFIT (TYP) NEW COVERED PORCH NEW WOOD DECKING FAMILY / FOLDING COUNTER

2'-6"

KITCHEN

REMOVE & ČÍDO DO OPEN TO REPLACE OF ABOVE STAIR TO STAIR

EXIST. LIVING

EXIST OPENING

REMOVE EXISTING STAIR AND WINDOW

EXIST. RECEPTION

9'-0" CLG.

EXIST. COVERED PORCH

REPLACE WINDOW WITH DOOR & LOWER SILL

FILL IN FLOORI JOISTS AFTER REMOVING STAIR

JREMOVE & FILL

A/C

BR #3 8'-0" CLG.

NEM BATH

LINEN STORAGE &'-o" CLG.

EXIST. BATH

EXIST. MBR

Second Floor Plan

Scale: 1/4" = 1'-0"

NEW TURNED 6" POST TO MATCH

NEW COVERED
PORCH
(OPEN TO UPPER RAFTERS)

EXIST. BR #2 \$'-0" CLG.

DOUBLE 62"x75"

ISSUES Description ZONIK COMMENTE 3/2/2 2 HE COMMENTE, 3/12/22

REVISIONS

ZONING COMPENT 3/2/12

HPC COMMENTS 6/12


Date

Description

Mark Alexander Pavliv, AIA

77 Main Avenue, Suite 101 Ocean Grove, NJ 07756

(732) 776 – 8777 NJ Lic No. AI00820300 springlakearchitect.com mp77aia@aol.com

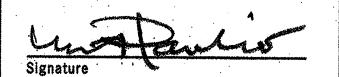


Proposed Renovations & Rear Addition to the Existing 2 1/2 Story **Wood Frame Single-Family Dwelling** Block #115, Lot #6 Use Group: R5 **Construction Type: 5B**

PROJECT NAME O'Connor Residence 7 Ocean Pathway Ocean Grove, NJ

DRAWING TITLE


First & Second Floor Plans

SCALE As Noted	JOB No. 2022990078
DATE 1/21/22	DRAWING No.
DRAWN BY	A4
CHECKED BY	

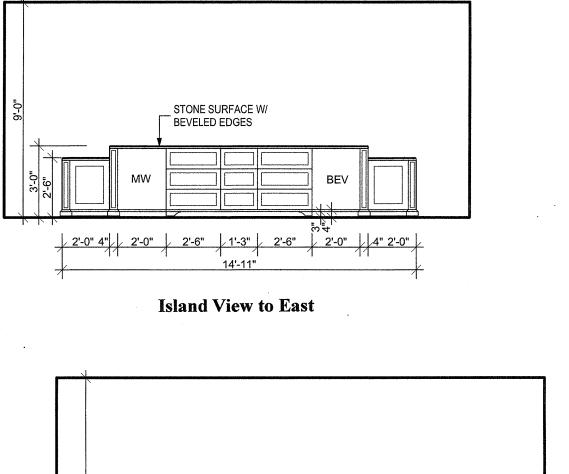


STONE SURFACE W/

BEVELED EDGES

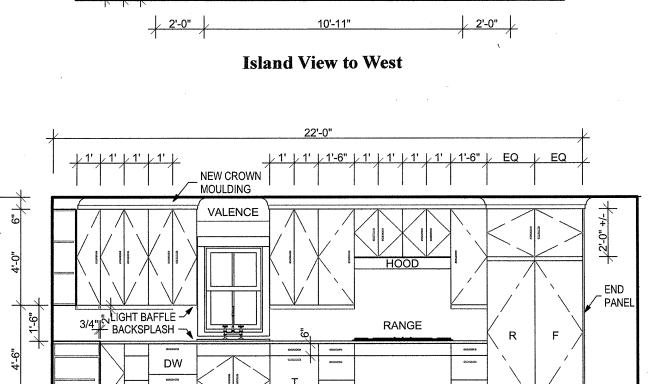


View to West Alley

First Floor Plan Scale: 1/4" = 1'-0"

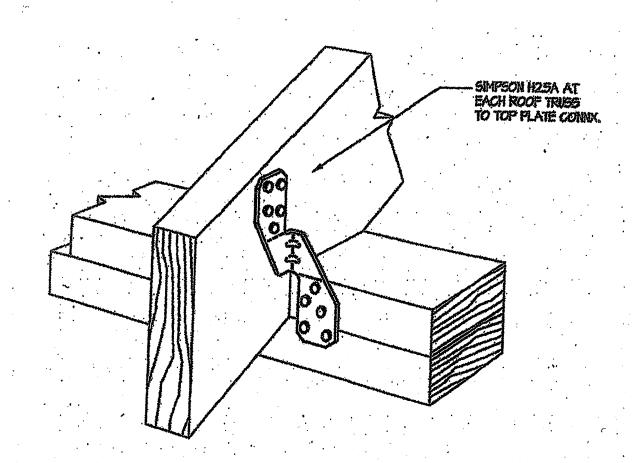

Typical New Rafter Hold Down
Scale: NTS

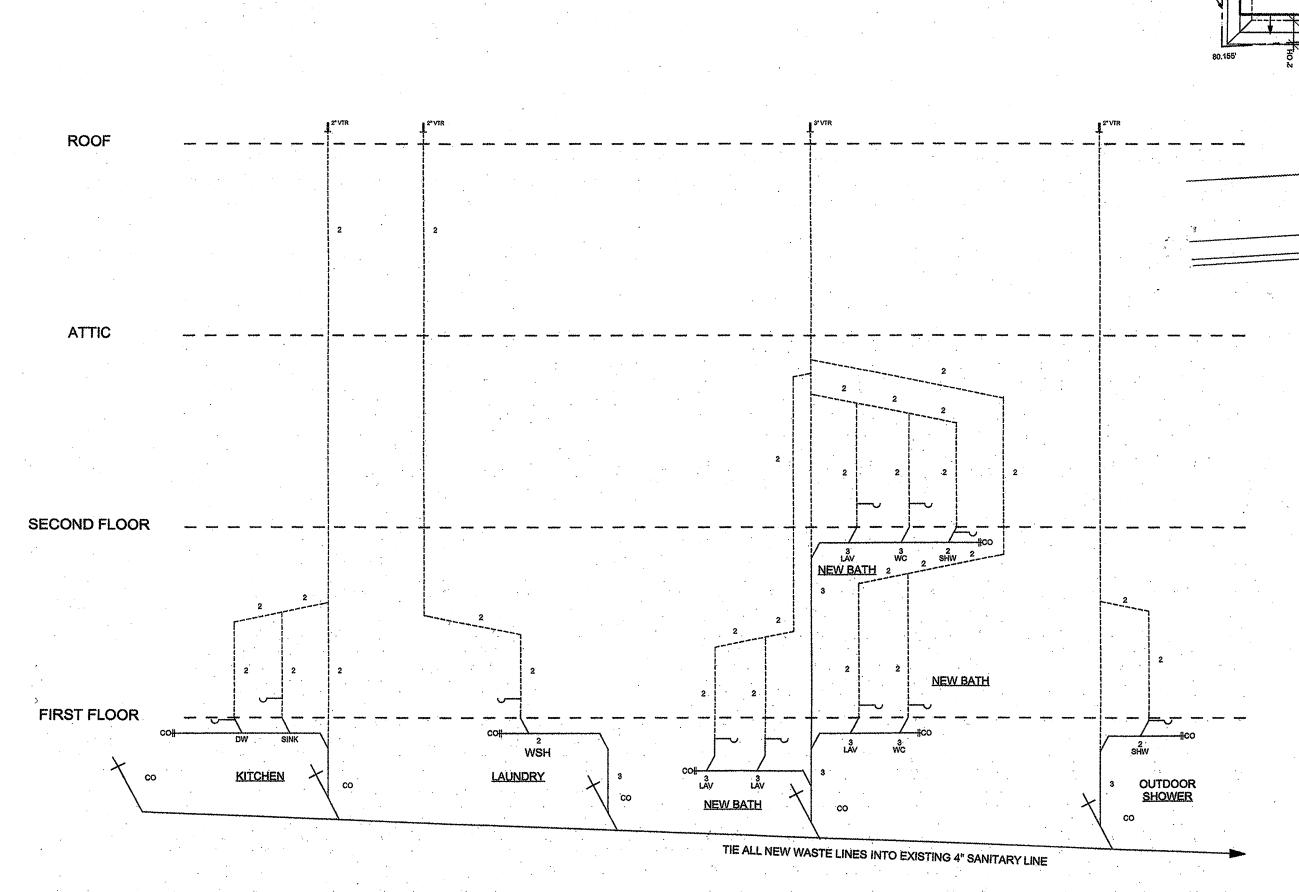

Roof Plan
Scale: 1/8" = 1'-0"


20" PENT ROOF-

Design loads in accordance with the 2021 IRC/NJ Edition to be:

20 pounds per sq. ft. Snow and Roof Load: Attic Live Load: 20 pounds per sq. ft. First Floor Live Load: 40 pounds per sq. ft. Second Floor Live Load: 30 pounds per sq. ft. Design Wind Load: 120 miles per hour All work to be in accordance with the 2021 IRC/NJ Edition

Smoke and Carbon Monoxide Detection:

Provide interconnected 110v smoke detector in accordance with IRC 2021 New Jersey Edition - as indicated on all floor plans. Smoke and Carbon Monoxide detection devices to be provided within vicinity of each sleeping area and no further than 10 feet from outside (entry door) of each bedroom.

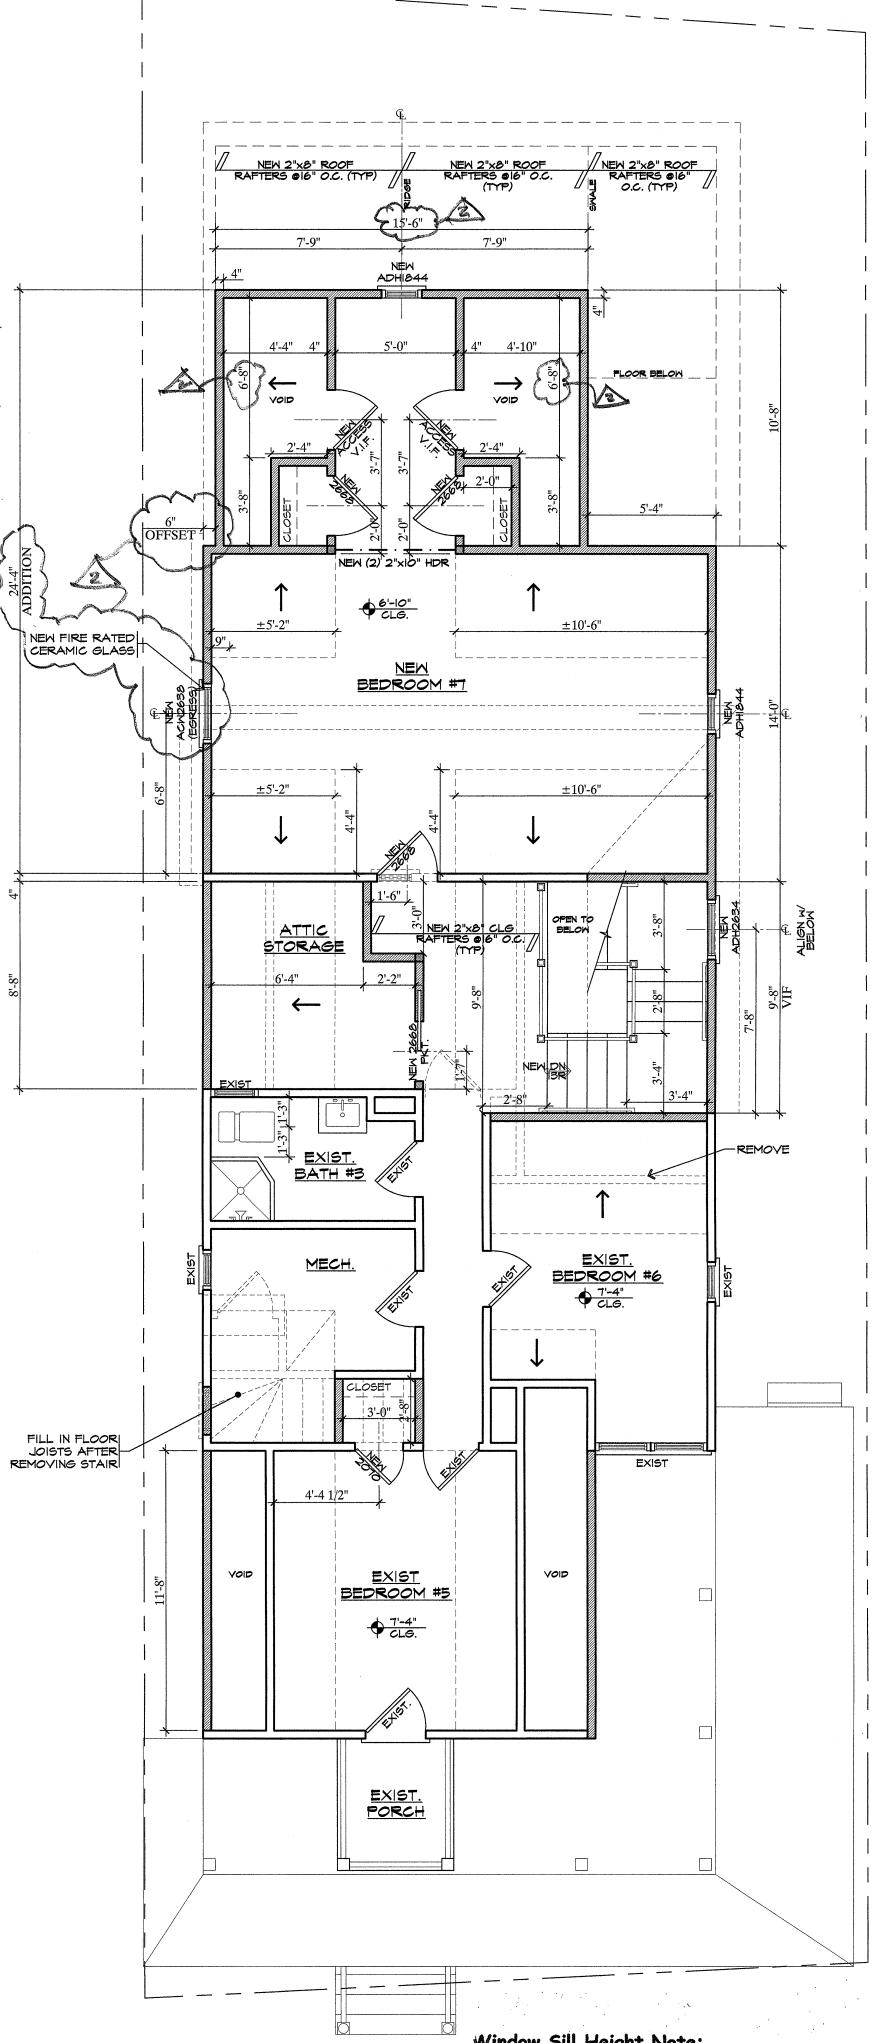

Window Sill Height Note:

Attic Level Plan

Scale: 1/4" = 1'-0"

Contractor to verify all second and attic level window sill heights to be at or above 24 inches of finish floor in accordance with Code.

	REVISIONS	
No.	Description	Date
1	ZONING COMMENTS	3/21/8
V	ZONING COMMENTS	6/2/2
		1 1 1

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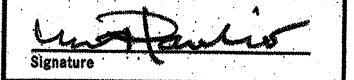
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Mark Alexander Pavliv, AIA

77 Main Avenue, Suite 101 Ocean Grove, NJ 07756

(732) 776 - 8777 NJ Lic No. AI00820300 springlakearchitect.com mp77aia@aol.com



Proposed Renovations & Rear Addition to the Existing 2 1/2 Story **Wood Frame** Single-Family Dwelling Block #115, Lot #6 Use Group: R5 **Construction Type: 5B**

PROJECT NAME O'Connor Residence 7 Ocean Pathway Ocean Grove, NJ


Attic/Roof Plan, Plumbing Riser

JOB No. 2022990075 As Noted 1/31/23 **A5** DRAWN BY EXC/MP

Plumbing Riser Diagram


Special Note:


Plumbing Riser diagram provided as a guide for filing of Plumbing Sub-code Permit Application, to be filed by Plumbing Contractor.

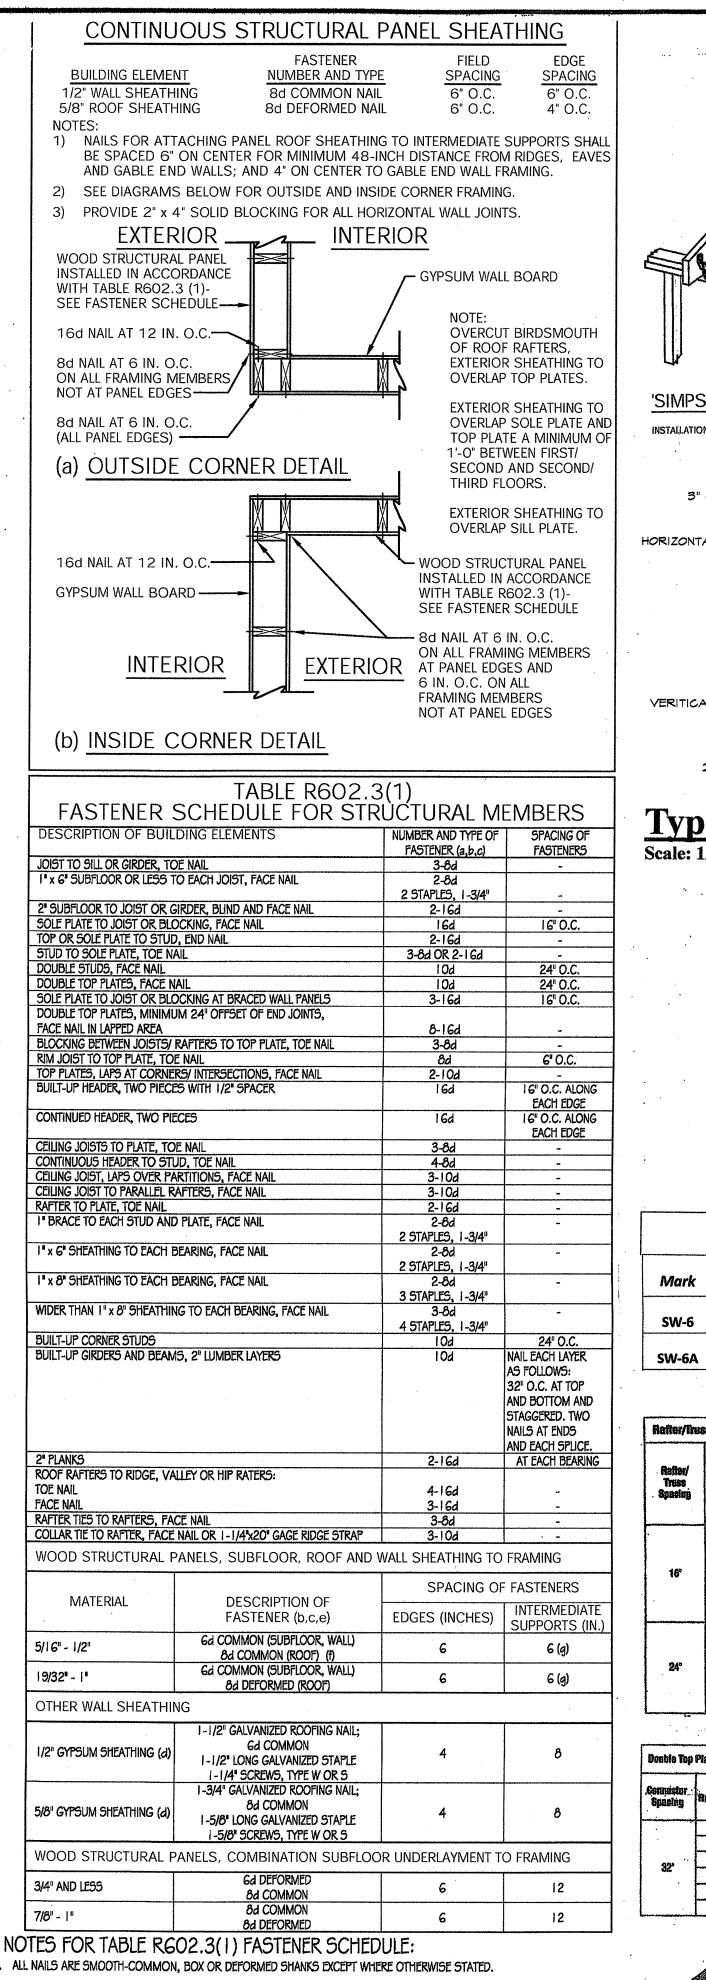


- STAPLES ARE 16 GAGE WIRE AND HAVE A MINIMUM 7/16-INCH ON DIAMETER CROWN WIDTH
- NAILS SHALL BE SPACED AT NOT MORE THAN 6-INCHES ON CENTER AT ALL SUPPORTS WHERE SPANS ARE 48-INCHES
- . FOUR-FOOT BY EIGHT-FOOT OR FOUR-FOOT BY NINE-FOOT PANELS SHALL BE APPLIED VERTICALLY. . SPACING OF FASTENERS NOT INCLUDED IN THIS TABLE SHALL BE BASED ON TABLE R602.3(2).
- 8d DEFORMED NAILS SHALL BE USED FOR ATTACHING PLYWOOD AND WOOD STRUCTURAL PANEL ROOF SHEATHING
- TO FRAMING WITHIN MIN. 48-INCH DISTANCE FROM GABLE END WALLS.
- 48-INCH DISTANCE FROM RIDGES, EAVES AND GABLE END WALLS; AND 4 INCHES ON CENTER TO GABLE END WALL FRAMING. GYPSUM SHEATHING SHALL CONFORM TO ASTM C 79 AND SHALL BE INSTALLED IN ACCORDANCE WITH GA 253.

NAILS FOR ATTACHING PANEL ROOF SHEATHING TO INTERMEDIATE SUPPORTS SHALL BE SPACED 6 INCHES ON CENTER FOR MIN.

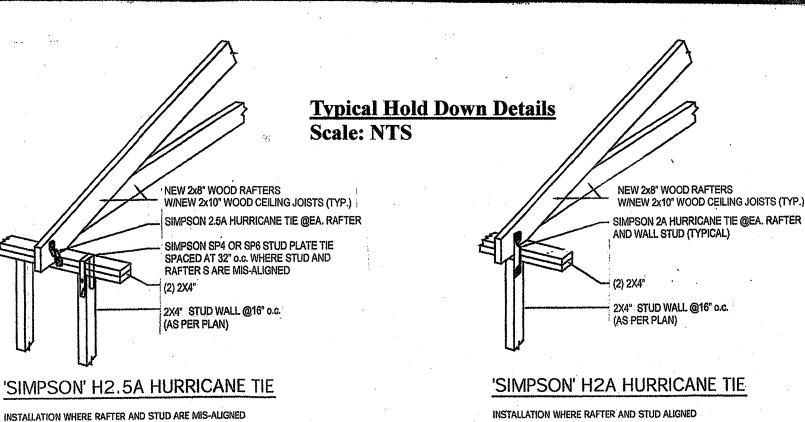

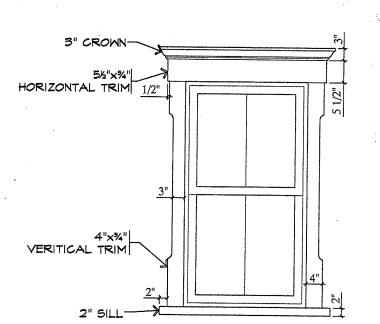

Typical Window Trim Detail Scale: 1/2" = 1'-0"

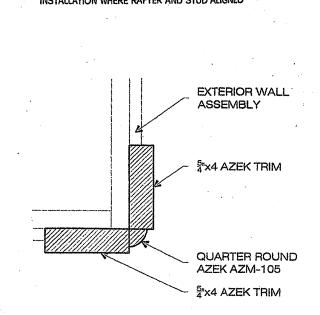

Typical Framing Corner Board Detail


Shear Wall Schedule **Sheathing Type** Fastener Value 8d common nails at 3" at sheet edges One Side - 7/16" OSB 6" o.c. in field - edges blocked 490 PLF 8d common nails at 3" at sheet edges

6" o.c. in field – edges blocked


Rafter/ Truss Spaning Span (VI)	Blov		DI Tarangan	/SP			SPF	SPF		
	Roof Span	109 -110 (mph)	111 -128 (mph)	121 -130 (mph)	181 -140 (mpb)	100 -110 (mph)	111 -120 (soph)	121 -186 (mph)		
***************************************	20' 24'			HŽ.5A					* #	H2.5A
16°	28'	H2.5A	H2.5A A		HB	H2.5A MTS12	H2.5A	118		
	38' 40'		, H8	H8	MTS12		H8	MTS12		
***************************************	20'	H2.5A		· H8	MTS12	1/2.5A	H8			
24°	28"		HB MTS12				MISI2			
	36° 40'	H8	W1812	HTS16	HTS16	H8 Misi2	MTS12	HTS16		

Both Sides - 7/16" OSB

Donble Top	Plate-to-Eve	ry Other Stud (One Story & To	p of Two Story)	•		. WFG1	Table 2.20												
A	Mar.		DE DE	/8P	~~~~~		SPF													
Connector Spacing	Roof Span (W)	100-110 (mph)	111-120 (mpb)	121-190 (mph)	131-140 (mpb)	100-110 (mph)	111-120 (mph)	121-130 (mph)												
•	20' 24'		H8	SP4/SP6	H8	SP4/SP6														
32"	28'	HB			. •	. •	. •	,	,	. •	,	,		SP4/SP6	,			SPH4/SPH6		
32	32'		arword	SPH4/SPH6		SP4/SP6	SPH4/SPH6													
	36'		SPH4/SPH6		SPH4/SPH67		arrm/arno	SPH4/SPH												
	40'	SP4/SP8			07 11-205 110	SPH4/SPH6		Or MARCHIO.												

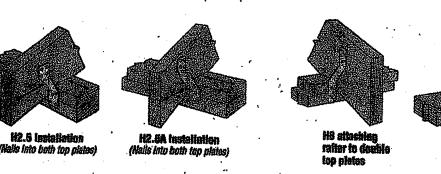




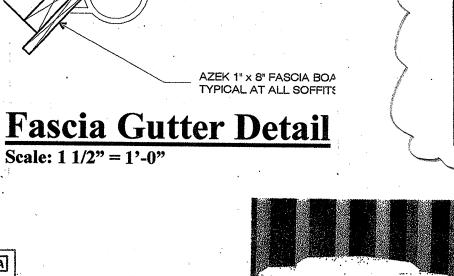


5" HALF-ROUND GUTTEF


980 PLF

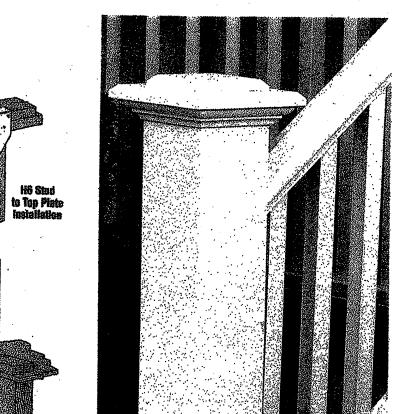





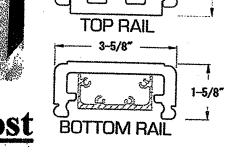

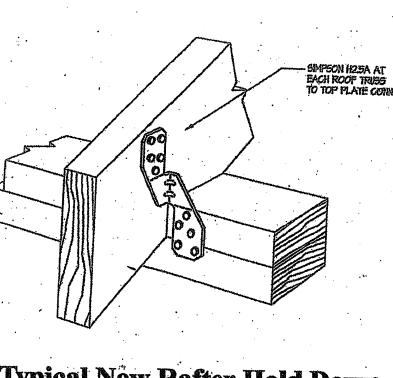

NEW 1 3" X 12" LVL RIDGE.

NEW CLOSED CELL SPRAY

FOAM INSULATION (R-60)

NEW FIBERGLASS BATT

WALL STUD AREAS

INSULATION (R-15) IN ALL

NEW OR EXPOSED EXTERIOR

NEW 2X10" WOOD

JOISTS AT 16" o.c.

WOOD BASE (TYP.) -

PLATE (TYP.)

Second Floor

PROVIDE FIBERGLASS BATT

INSULATION (R-15) IN ALL

EXTERIOR WALL AREAS (TYP)

2x10" WOOD JOISTS @16" o.c.

WHERE INSUL IS MISSING

OF DEFICIENT,

First Floor

@ 16" o.c. (TYPICAL)

ALL NEW INTERIOR WALL

STUD @ 16" o.c. (TYPICAL)

PLYWOOD SUBFLOOR.

EXISTING 2x4" WOOD STUDS

PARTITIONS TO BE 2X4" WOOD

NEW T&G 3/4" GLUED & SCREWED

(SEE FINISH SCHEDULE)

EXISTING 2X8" WOOD

Basement

JOISTS AT 16" o.c.

FINISH FLOOR

Scale: 1" = 1' - 0"

EXISTING EXPOSED STUD

IN ALL NEW ATTIC CEILINGS

(2) 2X4" TOP PLATE W/2X4" STLLI

2X8" COLLAR TIES @ 16" o.c.

PROVIDE NEW 5/8" DENSGLASS

SHEATHING AT ALL AREAS OF

NEW OR ALTERED WORK IN

ORDER TO ATTAIN 1 HR RATED

ASSEMBLY AT NEW OVERHANGS


WITHIN 5 FEET OF PROPERTY

LINE. (TYP.)

Typical New Rafter Hold Down


Special Section Detail Notes:

- PROVIDE NEW SHEATHING IN ALL AREAS OF RE-SIDING WHERE NO SHEATHING EXISTS.
- 2. ALL GUTTERS AND LEADERS TO BE NEW FACTORY WHITE FINISHED HALF ROUND ALUMINUM WITH EXPOSED STRAP HANGERS AND ROUND LEADERS IN A MATCHING WHITE COLOR.
- ALL EXPOSED WALL CONDITIONS WILL REQUIRE THAT INSULATION IS TO BE PROVIDED IN ACCORDANCE WITH ENERGY COMPLIANCE AND SPECIFICATIONS.
- 4. ALL EXPOSED ELECTRICAL WIRING AND SERVICE DEVICES WITHIN ALL EXPOSED INTERIOR WALL PARTITIONS AND CEILINGS ARE TO BE UPGRADED TO MEET CODE AS REQUIRED.

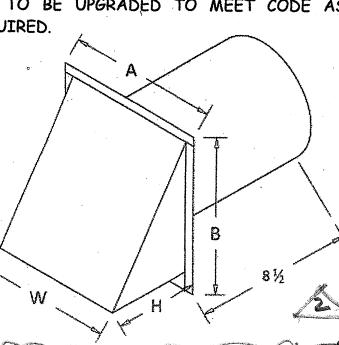

	3.	· Vindenda	V	•	¥	
Typic	al	Kit	chen	R	cha	net
			VII VI			UDU
Scale: NTS						

	SIZE	Α	В	W	Н
ľ	3	6	6 ½	5	3 1/4
	4	6	6 1/2	5	3 1/4
	5	7	7½	6	3 1/4
	6	8	8 1/2	7	4 1/2
ľ	7	9	9 1/2	8	5
Ī	8	10	10 ½	9.,	5 3/4
	10	13	13 ½	12	63/4
Ī	12	15	15 ½	14	8
	14	17	17 1/2	16	9 3/4

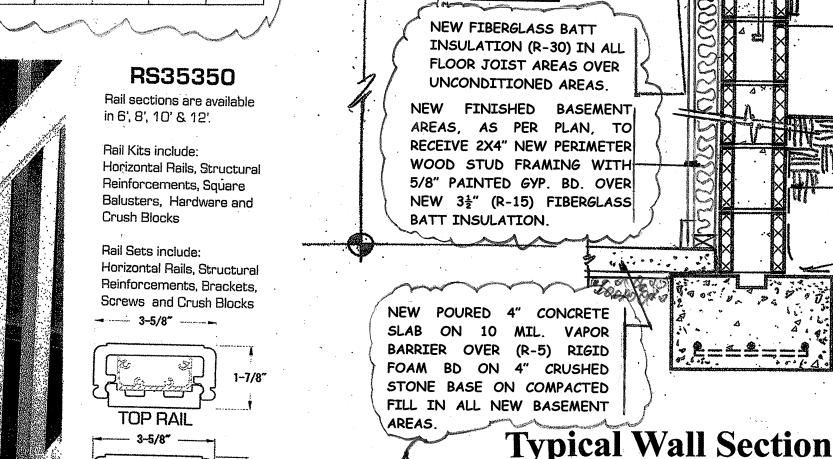

PROVIDE & INSTALL NEW SIMPSON STRONG TIE H2.5A AT EACH NEW ROOF RAFTER @ 16" o.c. (TYPICAL)

asphalt roof shingle as SPECIFIED OVER 30# FELT OVER 5/8" COX SHEATHING TO BE INSTALLED TO MEET OR EXCEED 120 MPH WIND LOAD.

NEW WOOD ROOF RAFTERS TO BE 2X10"; PACK OUT ALL 2X8" RAFTERS TO ACCOMMODATE (R-7) PER INCH MIN. CLOSED CELL INSUL AT ATTIC CEILING AREA.

NEW HALE ROUND ALUMINUM - GUTTER AND LEADER

NEW AZEK BOARD FASCIA

-11/2" AZEK FASCIA BOARD (TYP) NEW AZEK BEADED BOARD SOFFIT TO BE ORIENTED PERPENDICULAR TO BUILDING

PERIMETER (TYPICAL) 2×4" WOOD SILL PLATE

FIBERSTRAND RIM JOIST

(2) 2x4" WOOD PLATE

NEW CLOSED CELL (R-21) IN ALL NEW CONSTRUCTION EXTERIOR STUD CAVITIES.

NEW WINDOWS TO BE AS PER WINDOW SCHEDULE: PROVIDE 5/4" AZEK CASINGS AS PER ELEVATION DRAWINGS. (TYP.)

½" CDX PLYWD SHEATHING NAILED TO CODE.

NEW 4" EXPOSURE CEMENT PLANK HORIZONTAL CLAP BOARD SIDING OVER DUPONT TYVEK VAPOR BARRIER

2x4" WOOD SILL PLATE WHERE

CENTER PLYWOOD, SHEATHING OVER SECOND FLOOR JOIST

over 1 3" fiberstrand Rim

(2) 2x4" Wood Plate. NEW 5/8" INTERIOR GYPSUM BOARD. PROVIDE NEW 2X4" @ 16" o.c.

WOOD WALL FRAMING. INEW JAMES HARDIE LAP BOARD SIDING OVER NEW TRI-FLEX 30 VAPOR BARRIER W/DOUBLE TAPE AT ALL SEAMS: ON EXTERIOR GRADE COX PLYWD SHEATHING:

2X4" WOOD SILL PLATE (TYP.)

1 ½"X 18"L ANCHOR BOLT @ 4" o.c. THROUGH NEW 2X6" ACO PRESSURE TREATED FON SILL PLATE ON BATT SILL W/TERMITE SHIELD.

NEW 8" CONCRETE BLOCK FON WALL ON NEW 12" x 24" x 12" DEEP POURED CONCRETE FOOTING ON UNDISTURBED SOIL. (3,500 psi)

APPROXIMATE LINE OF GRADE (VARIES)

PROVIDE (2) COATS OF SPECIFIED BITUMINOUS DAMP-PROOFING BELOW GRADE OVER NEW CEMENT PARGE (TYPICAL).

CEMENT PARGE COVE DETAIL PRIOR TO DAMP-PROOFING APPLICATION, AS SHOWN

NEW 24" WIDE X 12" DEEP POURED CONCRETE FOOTING W/3 CONTINUOUS #4 STEEL REINF BARS, AS INDICATED.

Samuel Comment of the State of FINISHED BASEMENT AREAS. AS PER PLAN, TO RECEIVE 2X4" NEW PERIMETER WOOD STUD FRAMING WITH 5/8" PAINTED GYP. BD. OVER NEW 3½" (R-15) FIBERGLASS BATT INSULATION.


REVISIONS Description HPC COMMENTS FURL JELL UPPARE

No.	Description	Date
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	& 2021 IECC UPDATE	1
		3

Mark Alexander Pavliv, AIA

77 Main Avenue, Suite 101 Ocean Grove, NI 07756

(732) 776 - 8777NJ Lic No. AI00820300 springlakearchitect.com mp77aia@aol.com

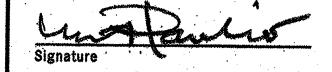

Proposed Renovations & Rear Addition to the Existing 2 1/2 Story **Wood Frame** Single-Family Dwelling Block #115, Lot #6 Use Group: R5 **Construction Type: 5B**

PROJECT NAME

O'Connor Residence 7 Ocean Pathway Ocean Grove, NJ

Typical Construction Section & Details

SCALE As Noted 2022990078 DRAWING No. 1/31/23 DRAWN BY A₀ CHECKED BY CM





Room or Area	Floor	Base/Trim	Wall	Ceiling	Special Notes
FIRST FLOOR	11001				
Reception Entry	Refinish Existing	Painted Wood	Painted Gyp. Bd.	Painted Gyp. Bd. w/Crown Molding	
Living/TV Room	Refinish Existing	Painted Wood	Painted Gyp. Bd.	Painted Gyp. Bd. w/Crown Molding	
Kitchen	New Hardwood	Painted Wood	Painted Gyp. Bd.	Painted Gyp. Bd.	Quartzite Countertops w/Custom Finish Cabinet
Family Dining Area	New Hardwood	Painted Wood	Painted Gyp. Bd.	Painted Gyp. Bd. w/Crown Molding	
Laundry	New Stone Tile	Painted Wood	Painted Gyp. Bd.	Painted Gyp. Bd.	
Half Bath	New Stone Tile	Painted Wood	Painted Gyp. Bd. 36" High Beaded Board Wainscot	Painted Gyp. Bd.	Vanity w/Stone Top
Stairwell to Second Floor	New Hardwood	Painted Wood	Painted Gyp. Bd.	Painted Gyp. Bd.	Stained Wood Hand Rail with painted newel post & painted square spindles;
SECOND FLOOR			. •		
		D. C. 4 . 1 W/ 4	Dainted Gran Rd	Painted Gyp. Bd.	
New Stair/Hall Area		Painted Wood	Painted Gyp. Bd. Painted Gyp. Bd.	Painted Gyp. Bd.	
New Hall Linen	New Hardwood	Painted Wood Painted Wood	Painted Gyp. Bd.	Painted Gyp. Bd.	Patch as required;
MBR	Refinish Existing	Painted Wood	Painted Gyp. Bd.	Painted Gyp. Bd.	Reframe floor joists;
New MBR WIC	New Hardwood		Existing	Existing	100110 110 01 g 011111,
MBR/Hall Bath	Existing New Hardwood	Existing Painted Wood	Painted Gyp. Bd.	Painted Gyp. Bd.	Patch as required;
BR #2 New Hall Bath	New Stone Tile	Painted Wood	Full Stone Walls; in Shower Stall on WR Cement. Bd; 36" High Beaded Board Wainscot	WR Cement Bd. Stone Ceiling in Shower Stall;	Stone Counter Top; Frameless Tempered Glass Door in Shower;
New BR #3	New Hardwood	Painted Wood	Painted Gyp. Bd.	Painted Gyp. Bd.	
New BR #4	New Hardwood	Painted Wood	Painted Gyp. Bd.	Painted Gyp. Bd.	
Stairwell to Attic Level	New Hardwood	Painted Wood	Painted Gyp. Bd.	Painted Gyp. Bd.	Stained Wood Hand Rail with painted newel post & painted square spindles;
ATTIC LEVEL					•
New Stair/Hall Arc	ea New Hardwood	Painted Wood	Painted Gyp. Bd.	Painted Gyp. Bd.	
Attic Hall Storage	New Hardwood	Painted Wood	Painted Gyp. Bd.	Painted Gyp. Bd.	•
BR #5	Existing	Existing	Existing	Existing	Patch as required;
BR #6	Existing	Existing	Existing	Existing	Patch as required
New Mech Closet	Unfinished Plywd	Painted Wood	Painted Gyp. Bd.	Painted Gyp. Bd.	Reframe floor joists;
Hall Bath	Existing	Existing	Existing	Existing	
New BR #7/Studio	_	Painted Wood	Painted Gyp. Bd.	Painted Gyp. Bd.	
BASEMENT				- m	
Stairwell to	New Painted Wood	Painted Wood	Painted Gyp. Bd.	Painted Gyp. Bd.	
	New Ceramic Tile	Painted Wood Painted Wood	Painted Gyp. Bd.	Painted Gyp. Bd.	
Bike Storage	New Ceramic Tile	Painted Wood Painted Wood	Painted Gyp. Bd.	Painted Gyp. Bd.	
New Playroom	new Ceranne The	i aiiticu wood	r amieu Oyp. Du.	ramou Oyp. Du.	
New Half Bath	New Ceramic Tile	Painted Wood	Painted Gyp. Bd.	Painted Gyp. Bd.	•

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	A	11	•		

-All interior trim, casings and baseboard profiles to be Painted Pine as detailed in profile approved by Owner. -Provide Crown Moldings as per Finish Schedule. Crown moldings may be painted MDF in lieu of Painted Wood. -All references to "Hardwood" indicates new hardwood floors in finish to be selected and approved by Owner. -All references to "Stone" or "Tile" indicate all new stone or tile with final selection to be by Owner.

Owner Submittal Requirements:

Hardware prior to the order of material.

Contractor to provide sample and associated catalog

information to Owner for final selection of any and all items


not specified or discontinued by manufacturer at time of construction, including Soffit Brackets, Exterior Light

Fixtures, all Moldings and Decorative Trim and Door

	<u>Quantity</u>	<u>Dimensions(w x h)</u>	Thickness	Door Type	<u>Material</u>	Pattern/Style/Special Note
FIRST FLOOR Half Bath	1	24" x 84" (2070)	1 3/4"	Hinged	Wood	4-Panel
	2	24" x 84" (2070)	1 3/4"	Hinged	Wood	4-Panel
	1	36" x 84" (3070)	1 3/4"	Pocket	Wood	4-Panel
SECOND FLOOR		entrementation and the second and th	***************************************			
MBR	1 Re-use	28" (w/transom)	1 3/8"	Hinged	Wood	4-Panel
MBR WIC	1	30" x 80" (2668)	1 3/8"	Pocket	Wood	4-Panel
MBath	1 Existing	28" (w/transom)	1 3/8"	Hinged	Wood	4-Panel
Hall Linen Closet	1	24" x 80" (2068)	1 3/8"	Hinged	Wood	4-Panel
Hall Linen Room	1	30" x 80" (2668)	1 3/8"	Pocket	Wood	4-Panel
BR #2	1 Re-use	28" (w/transom)	1 3/8"	Hinged	Wood	4-Panel
BR #3	1	30" x 80" (2668)	1 3/8"	Hinged	Wood	4-Panel
BR #3 Closet	1	30" x 80" (2668)	1 3/8"	Hinged	Wood	4-Panel
HallBath	1	30" x 80" (2668)	1 3/8"	Hinged	Wood	4-Panel
BR #4	1	30" x 80" (2668)	1 3/8"	Hinged	Wood	4-Panel
BR #4 Bath	1	30" x 80" (2668)	1 3/8"	Hinged	Wood	4-Panel
BR #4 Closet	1	24" x 80" (2068)	1 3/8"	Hinged	Wood	4-Panel
ATTIC LEVEL						
BR #5	1 Existing	28" x 80" (2468)	1 3/8"	Hinged	Wood	4-Panel
BR #5 Closet	1	24" x 80" (2068) VI	F 1 3/8"	Hinged	Wood	4-Panel
BR #6	1 Existing	28" x 80" (2468)	1 3/8"	Hinged	Wood	4-Panel
Hall Bath	1 Existing	28" x 80" (2468)	1 3/8"	Hinged	Wood	4-Panel
Attic Mech Room	1 Existing	28" x 80" (2468)	1 3/8"	Hinged	Wood	4-Panel Undercut
Attic Storage Room	1	32" x 80" (2068)	1 3/8"	Pocket	Wood	4-Panel
Hall Linen Closet	1	24" x 80" (2068)	1 3/8"	Hinged	Wood	4-Panel
BR #7	1	30" x 80" (2668)	1 3/8"	Hinged	Wood	4-Panel
BR #7 Closets	2	30" x 80" (2668)	1 3/8"	Hinged	Wood	4-Panel
Mech Access Panels	2	30" x 60" VIF	1 3/8"	Hinged	Insulated Wood	1-Panel w/Gasket
BASEMENT LEVEL						
Storage/Mech Area	1	36" x 80" (3068)	1 3/8"	Hinged	Wood	Louvered
Bath	1	30" x 80" (2668)	1 3/8"	Hinged	Wood	4-Panel
Game/Play Room	1	36" x 80" (3068)	1 3/8"	Hinged	Wood	4-Panel
Closet under Stair	1	30" x 80" (2668)	1 3/8"	Hinged	Wood	4-Panel

Special Notes:

Contractor to verify all interior door dimensions in field prior to placement of order and installation. All interior doors to be 4 panel type or as other noted. Any upgrades and/or deviations from the above are to be submitted to Owner for review approval. All final hardware selections subject to Owner approval. Refer to provided Specifications for hardware and finishes.

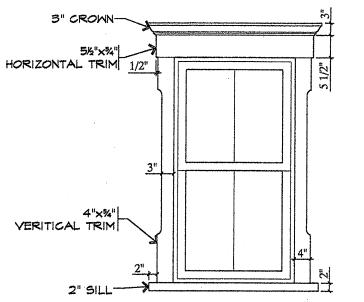

2" SILL-	2"	2	.,1
Ext	erior Casin	ισ Detai	:
	$\frac{2"}{101} = 1' - 0"$	ig Detai	

Room or Area FIRST FLOOR	Quantity	Manufacturer #	Glazing	Egress	SDL Detail	Type/Comments
Reception Hall Area	1	Existing	Existing	N/A	(see elevation)	Front Inswing Doo
•	2 2	Existing Existing	Existing Existing	N/A N/A	(see elevation) (see elevation)	Double Hung South Double Hung E/W
Living Area	2 1	ADH2650 ADH2650	Low E4 Low E4	N/A N/A	2 over 2 lite 2 over 2 lite	Double Hung East Double Hung West
Kitchen	1	ADH2638	Low E4	N/A	2 over 2 lite	Double Hung West
Half Bath	1	ADH2638	Low E4	N/A	2 over 2 lite	Double Hung East
Mud Rm/Laundry	2	ADH2638	Low E4	N/A	2 over 2 lite	Double Hung
Side to Basement	1	Therma-Tru 36"x80" Benchmark	Low E Tempered Glass	N/A	4 lite (see elevation)	Outswing Door; Smooth/"Real Red
Family Dining Area	2	ADH2650	Low E4	N/A	2 over 2 lite	Double Hung North
	2m (ADH2650	Low E4	N/A	2 over 2 lite	Double Hung West
		FWID40611	Low E4 Tempered Glass	N/A	1 lite (see elevation)	Patio Doors North
	1	Simpson Wood Door 2870	Low E Tempered Glass	N/A	2 over 3 lite Upper Glass Panel	In-swing Door East
SECOND FLOOR	,		·			
MBR	2	Existing	Existing	N/A	2 over 2 lite	Double Hung South
	1	Existing	Existing	N/A	2 over 2 lite	Double Hung West
	1	Existing Existing Door	Existing Existing	N/A YES	2 over 2 lite (see elevation)	Double Hung East In-swing Door Sout
MBR WIC	1 :-	ADH2030	Low E4	N/A	2 over 2 lite	Double Hung West
MBR Bath	1	ADH2648 VIF	Low E4	N/A	2 over 2 lite	Double Hung West
Stair Landing to Second Floor	1	ADH2648	Low E4 Tempered Glass	N/A	2 over 2 lite	Double Hung East
Bedroom #2	1	ADH2648	Low E4	N/A	2 over 2 lite	Double Hung East
	1	Simpson Wood Door 2670 VIF	Tempered	YES	2 over 3 lite	In-swing Door Sout
Bedroom #3	3	ADH2648	Low E4	N/A	2 over 2 lite	Double Hung
	1	FWHID29611	Low E4 Tempered	YES	2 over 3 lite	In-swing Door Nort
Bedroom #4	2	ADH2648	Low E4	N/A	2 over 2 lite	Double Hung North
	1/2	ADH2648 FWHID29611	Low E4 Low E4 Tempered	N/A YES	2 over 2 lite 2 over 3 lite	Double Hung East In-swing Door East
Bedroom #4 Bath	1	ADH2648	Low E4	NA	2 over 2 lite	Double Hung East
ATTIC LEVEL		And the second s		was the same of th		
Bedroom #5	1	Simpson Wood Door 2668 VIF	Low E4 Tempered	YES	2 over 3 lite	In-swing Door South
Bedroom #6	1	•	Existing Existing	N/A N/A	2 over 2 lite (see elevation)	Double Hung East Awning South
Mech Area	1	ADH2030	Low E4	N/A	2 over 2 lite	Double Hung West
Stair Landing to Attic Level	1		Low E4 Tempered Glass	N/A	2 over 2 lite	Double Hung East
Bedroom #7	1	ADH1844	Low E4	N/A	2 over 2 lite	Double Hung East
	1	ADH1844	Low E4 Low E4	N/A YES	2 over 2 lite faux 2 over 2 lite	Double Hung North Casement West
BASEMENT LEVEL						
Mech/Storage Area	4 replace	AAN3218 VIF	Low E	N/A	1 lite	Basement Utility
Basement Bath	1	AAN3218 VIF	Low E4	N/A	1 lite	Basement Utility
Play/Game Room	<u>2</u>	AAN3218 VIF	Low E4	N/A	1 lite	Basement Utility

Special Notes:

Window sizes as per Schedule to be verified in field by Contractor. Screens are to be provided throughout. Window Designations are referencing Andersen Windows and Doors - A-Series unless otherwise noted or approved by the Architect. All windows and doors to be factory clad exterior with factory finished interior. Exterior window frame and sash colors to be as approved by HPC.

Andersen windows and doors to be fibrex clad solid core wood with full divided lites with spacer bars and be manufactured with High-Performance Insulated Low-E4 Glazing, rated for maximum fade resistance, and have a factory painted white interior finish as manufactured by Andersen Windows and Doors. Provide window sash configuration as per elevations and provided Window Schedule as approved by HPC and Architect. Exterior Door and Window Sash color to be A-series "Red Rock" and Therma-tru "Real Red" subject to final approvals.

Interior window hardware to be factory white finish unless otherwise requested and approved by Owner. Exterior door hardware and locksets to be black, or as otherwise selected and approved by Owner and with black interior finish. All exterior hardware finishes are to be acceptable for exposure to salt air with warrantee against pitting. All new door hardware to be provided and installed by the Contractor.

Any upgrades and/or deviations from the above are to be submitted to Owner and Architect for review approval. Manufacturer's shop drawing and order list is to be submitted to Architect for review prior to placement of final order. Contractor is responsible to verify all window designations, egress compliance and sizes in field and notify Architect of any conflicts.

All glass to be tempered where bottom edge of glass is less than 5 feet from the floor at tub and shower areas, within a 24" arc of all hinged doors; or within 36" of any walking path and not separated by a railing with at least an 18" space between the railing and glazed surface. All glazed panels greater than 9 square feet in area or greater than 36 inch in edge to edge dimension or within 1 foot distance from adjacent doors or within the swing distance of a hinged door must be tempered.

Egress Windows (Doors) shall be provided with an operable opening having a sill height of not more than 44 inches, have a width of at least 20 inches and height of at least 24 inches, and have a minimum total area of 5.7 square feet measured from head to sill and side to side.

Simpson exterior doors are to be provided where noted on Schedule and subject to Shop Drawing approval by HPC and Architect.

Therma-tru exterior doors are to be provided where noted on Schedule and subject to Shop Drawing approval by HPC and Architect.


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Mark Alexander Pavliv, AIA

77 Main Avenue, Suite 101 Ocean Grove, NJ 07756

(732) 776 – 8777 NJ Lic No. AI00820300 springlakearchitect.com mp77aia@aol.com



Proposed Renovations & Rear Addition to the Existing 2 1/2 Story **Wood Frame** Single-Family Dwelling Block #115, Lot #6

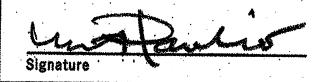Use Group: R5 **Construction Type: 5B**

PROJECT NAME

O'Connor Residence 7 Ocean Pathway Ocean Grove, NJ

DRAWING TITLE Interior Door, Window & Finish Schedules

As Noted 2022990075 DATE 1/31/23

CHECKED BY

Special Conditions:

Owner to Purchase and Supply the following:

- Kitchen cabinetry:
- Stone counter tops;
- Bathroom fixtures, accessories and faucet/shower fittings;
- Bathroom sink vanities: - Medicine cabinets:
- Kitchen appliances,
- Interior stone flooring and wall tile: - All surface mounted fans and lighting fixtures:

Owner's cabinetry fabricator to be responsible for installation of cabinets and counter tops. Contractor to also be responsible for installation of all other items purchased and supplied by the Owner as listed above, unless otherwise determined by Owner.

Contractor to be responsible for the storage and protection of all above items upon and after delivery to the project site until issuance of the final Certificate of Occupancy.

All exposed balloon stud framing to be fire blocked. Any partition stud framing found to be less than 3 ½" in depth shall be paired with new 2x4" wood stud framing.

Specifications:

Division 1 - General Conditions All work to comply with the 2021 International Residential Code/New Jersey Edition.

Upon acceptance of the Contract Documents and Agreement with the Owner, the General Contractor assumes full responsibility for the construction, materials, methods and workmanship necessary to complete the scope of the project as described in those documents and will execute the work in the conceptual spirit and design intent in which the documents have been produced.

All construction permits are to be procured by General Contractor and paid by Owner.

The Contractor is responsible for becoming familiar with all existing site conditions and circumstances prior to the signing of the Agreement.

The Contractor is to comply with all General Notes and Requirements listed in the construction documents. Specifications have been provided to assist the Contractor in the implementation of the project.

Lead Paint, Asbestos or other Hazardous Material:

Contractor responsible for the identification and removal of any of the above noted environmentally sensitive materials in a manner that is safe and in compliance with all health and safety requirements, in the event such materials are found during the course of demolition, or construction, at no additional cost to the Owner.

Demolition and Removals:

All existing partitions, fixtures and finishes within the proposed area of work graphically indicated on plans or otherwise required to be removed to complete the proposed renovations, are to be removed.

Contractor is responsible for the provision and associated costs of all required demolition, dumpsters, removals and disposal of debris in accordance with local regulations.

Division 2 - Site Work

Site Work:

Contractor to restore any and all disturbed grade conditions immediately adjacent to work areas in an orderly and workmanlike manner as may be required at the completion of the project.

Site work by Contractor to include setting of new AC Unit pads and installation of new walks as indicated on site plan.

Controlled roof drainage to be maintained via a gutter and leader system which must collect and discharge roof water to the ground surface to a minimum distance of 5 feet from the foundation wall onto permeable soil so as to recharge the site in accordance with R801.3.

Division 3 - Concrete

New footings, where indicated on Foundation Plan. are to be poured concrete suitable for soil bearing capacity of 2,500 lbs/sf min. Contractor to verify at site. All footings to sound bearing to 3'- 0" below grade. New footings are to be 12" deep with continuous #4 steel reinforcement bars, as indicated in details, and with a minimum of 16" overall width or as otherwise shown on plans and be of an ultimate

Concrete Block (CMU):

All new concrete block to be new 8" as indicated on Basement Foundation Plan. Solid core full with poured concrete at all point load bearing locations.

strength of not less than 3,000 psi in 28 days.

Concrete Slabs:

Fill compaction at concrete slabs to be 90% maximum density with modified proctor test ASTM D-698 or 95% maximum density with standard proctor test ASTM D-698. Provide 4" new poured concrete slab in all basement floor areas with new poured concrete slab on 6 mil vapor barrier over 5" compacted and levelled base.

Division 4 - Masonry

Masonry: Defective or deficient existing masonry foundation conditions are to be repointed and repaired. Additional found defective and deficient foundation conditions are to be brought to the attention of the Architect.

Existing Flue/Chimney:

Existing to be removed and replaced with new direct vents through basement foundation walls.

Division 5 - Metals

Contractor to provide hurricane/wind rafter tie downs at new framing in accordance with R802.11 or as otherwise noted in Typical Section Detail.

Fasteners & Hangers:

All metal hangers and other ties and connectors to be as manufactured by "Simpson" or equal or as otherwise approved by the Architect.

All metal hangers and other ties in contact with pressure treated ACQ lumber shall be zinc coated and compliant with ASTM A-153 so as to be compatible with ACQ as required.

Division 6 - Woods & Plastics

Lumber:

All new framing lumber to be Douglas Fir, Standard Grade and better with a minimum fiber stress of 1250 psi. All new porch deck framing to be erected with new Pressure Treated 40 year tagged material.

Nail applications to Code. All replacement sill plates in areas where foundation walls are to be reconstructed. and are to be in contact with concrete foundation, shall be ACQ Pressure Treated.

New window and door headers to be a minimum of two (2) 2"x10" or 3 ½" x 9 ½" LSL or as otherwise approved by the Architect due to field conditions.

Use of long span manufactured lumber and laminated beams as an alternate or in deviation from that specified on the drawings is subject to compliance with manufacturer's recommended load and span tables and must be approved by the Architect prior to such substitution or change.

Contractor to utilize wall bracing panel construction method R602.10.3 which specifically states that "Wood structural panel sheathing with a thickness not less than 5/16" shall be used for 16" stud spacing" and all structural panels shall be installed in accordance with Table R602.3 as provided in the Construction Documents or otherwise required by the Wood Framing Construction Manual ANSI/AF&PA WFCM-2001 Edition and comply with 120 mph three (3) second wind gust

Sheathing:

New exterior wall sheathing to be 5/8" CDX plywood nailed to Code. Sheathing on any exterior walls within 5'-0" of property line to be 1-hour fire rated exterior grade gypsum board. Such wall assemblies shall be 1-hour fire rated for exposure on both sides.

Exterior new wall sheathing to be nailed to Code at 6 inch o.c. Alternative Sheathing to be OSB Windstorm oriented vertically to minimize horizontal blocking requirements,

Sub-floor:

Any new sub-floor to be 3/4" T&G applied and fastened with screws and glued. Use of OSB Gold Edge Bond is an acceptable alternate. All screws to be spaced at 6" to Code.

Exterior Architectural Trim:

All new ornamental architectural trim, brackets, window, drip and door caps and articulated door and window surrounds, as shown on the Elevations and Details to be synthetic polymer as manufactured by Azek, or approved equal and painted as specified. Approved equal subject to review by Architect. All window and door surrounds to be 5/4" thickness in order to attain proper dimensional relief and to conform to casing details provided in plans. All staple holes and fastening dibits to be filled and sanded in preparation of application of paint.

Porch Floor and Entry Stair Planking:

New exterior rear first floor covered porch area deck surface and stair treads and to be tongue and groove 3 ½ x 5/4" mahogany in stain finish. New porch decking surfaces to pitch to drain at 1/8" per foot minimum. New stairs to be box type constructed utilizing matching T&G treads and painted synthetic polymer risers and stringers.

Division 7 - Thermal & Moisture Protection Energy Code compliance to be in accordance with RESCheck as provided in the construction documents for the 2021 IECC Zone 4. Compliance shall conform with all ratings and description.

Insulation: Provide insulation at all new areas of framing and at all exposed exterior perimeter walls in existing areas of dwelling with new 3 ½" fiberglass batt type with a R-15 rating in 4" exterior wall cavities when existing insulation found to be missing or otherwise compromised.

Provide R-30 insulation in all basement, ceilings and at floor areas over unconditioned spaces where work is to be performed. Apply R-60 ceiling and R-21 wall spray foam closed cell insulation in all areas of proposed rear addition.

Application of caulk at any new or modified window and door perimeters as well as other through wall penetrations and joints are subject to approval by the Architect on-site.

Exterior Siding and Other Facings:

Exterior siding, or other facings, shall be rated and installed as per manufacturer's recommendations so as to withstand a minimum of 120 mph winds in this zone. New clap board siding to be smooth faced fiber cement board with 4" exposure as manufactured by James Hardie Corporation.

Contractor to provide hurricane/wind rafter tie downs in accordance with R802.11 as per the Typical Section Detail.

All exterior finishes, materials and facings are to be as shown on the Elevation Drawings. All siding and trim to match existing as approved by HPC. Any deviation is subject to approval by Architect and HPC.

New GAF self sealing Timberline Ultra asphalt shingle roofing to match existing dwelling

All new roofing shingles shall match existing and conform to ASTM 3462 with a minimum of 6 fasteners per shingle.

Existing Roofing:

Contractor to remove any existing roofing where noted on plan and properly dispose once removed.

Vapor Barrier Paper and Wraps:

Contractor to install Henry Company Blue Skin at all roofing sheathing prior to application of roof shingles. All exterior wall sheathing to receive Henry Company Blue Skin or as otherwise approved by Architect, with all seams and methods of installation in accordance with manufacturer specifications. Install ice and water shield over all roof conditions with a slope of less than 4 over 12.

Shower Stall Fiberglass Application and Pan:

New bathroom shower, bench and integral shampoo storage recess features to be fiberglass formed and water tested for inspection prior to tile application. All shower stalls to receive tile on full wall height, floors and ceilings.

Division 8 - Doors & Windows

New or replacement windows and doors shall be rated and installed as per manufacturer's recommendations so as to withstand a minimum of 120 mph winds in this zone.

Where required or otherwise noted on plans, egress windows shall be provided with an operable window vent or sash having a sill height of not more than 44 inches, and have a width of at least 20 inches and height of at least 24 inches, and have a minimum total area of 5.7 square feet measured from head to sill and side to side.

Any new windows to be manufactured with raised 7/8" full divided lite solid core wood units, where indicated, and be Low-E4 insulated clear glass with spacer bars and be as manufactured by Andersen Windows and Doors, A-Series in red rock outer sash color as approved by HPC, with factory finished white interior. Sizes for windows to be verified in the field or as otherwise identified on plans.

Contractor is responsible to verify provided window designations, egress compliance and sizes in field and notify Architect of any conflicts. Screens at any new windows are to match exterior sash color to be provided by Contractor. Interior window hardware to also be factory finished white.

All new sash glass to be tempered where bottom edge of glass is less than 5 feet from the floor at tub and shower areas. All glazed panels greater than 9 square feet in area or greater than 36 inch in edge to edge dimension or within 1 foot distance from adjacent doors or within the swing distance of a hinged door must be tempered.

Contractor's window vendor to prepare detailed shop drawings of all new or replacement windows and door for review and written approval by the Architect prior to placement of orders.

Solid Panel Interior Doors:

All new doors to be pre-hung four-panel solid core wood in natural finish, as approved by Owner. Door height and width dimensions, as noted on Interior Door Schedule.

Exterior Doors:

All specified new or replacement doors to be as indicated on Exterior Door Schedule and elevations, as manufactured by Simpson and Therma-tru Doors.

Attic Access:

Attic access to attic mechanical spaces to be provided with a minimum of 22" x 30" in clear opening. All access openings, panels and doors to have insulating gasket at door perimeter to assure tight fit and eliminate both air and mechanical noise transmission.

Division 9 - Finishes

Gypsum Board: All new interior Gypsum Board to be screwed and glued and

be 5/8" minimum unless otherwise noted on plans or Typical Wall Section Detail or fire rating requirements for exterior walls within 5 feet of side and rear property lines.

New Interior Staircase:

New Oak treads to be finished to match wood flooring. Risers to be painted Poplar wood. Railing to include a top articulated profile handrail to be stained hardwood in Owner's stain color choice. Balustrade spindles to be painted wood spindles to be selected by the Owner.

Interior Trim, Moldings & Hardware:

All new window and door casing and base trim to be new painted clear grade primed poplar wood and finished to highest quality and match existing. Sample to be approved by Owner. Any and all field conflicts and special conditions are to be brought to the attention of Architect. Trim with wood knots will not be acceptable.

Hardware to be as manufactured by Baldwin or equal. Hinges to be five (5) knuckle type. All hardware to be matching "satin nickel finish" with glass knob detail when approved by Owner. All room locksets to be passage type, with privacy locksets in all bathrooms and all Bedrooms. Contractor to submit samples of all hardware to Owner.

New Wood Flooring:

Interior wood flooring to be 2 1/4" Red Oak of highest quality and finished as per Owner. Provide minimum of 3 coats of satin polyethelene finish, in areas as indicated in the Finish Schedule. Sample of finished wood floor product to be provided for approval by Owner.

Install all new floor and wall tile, as provided by Owner, in accordance with the Finish Schedule. Utilize mortar set application method. All tile to be cleaned and sealed.

New Glass Shower Door:

Provide and install new frameless shower door with clear tempered and coated 3/8" glass as per Finish Schedule.

Kitchen/Vanity Countertops:

Countertop slabs to be 3/4" Quartzite, or other stone material, with edge detail and color, as selected by Owner. Fabricator to assist Owner in selection of edge detail.

Interior Panel Wainscot:

Proposed interior wainscot panels to utilize poplar veneer and moldings to attain 36" wall height with chair rail as detailed and/or specified in Finish Schedule. Interior wainscot wall panels to be applied to gypsum board walls. Sample panel to be provided in field for review and final approval by Owner. Wainscot Panels to be painted as specified and coordinated with placement of all openings, doors, window, crown and base trim.

Closet Rods & Shelving:

All interior bedroom, broom, linen and storage closet shelving to be factory finished white melamie board with steel hanging rods. Use of particle board is not acceptable.

<u>Interior Paint:</u> All interior walls to be primed and receive two coats of

window and door casings, and trim to receive two (2) coats of Benjamin Moore satin enamel paint. Contractor to utilize eggshell finish in all bath areas. Ceiling to be primed in areas of new gypsum board application and

receive two coats of Benjamin Moore ceiling white. All

paint colors and finishes subject to approval by Owner.

Benjamin Moore latex flat paint. Interior moldings, wainscot,

The areas not to be covered with facing material are to be painted with two coats of Benjamin Moore Latex or equal.

Exterior Railing Systems:

All new exterior railings, at proposed addition, to be painted Intex flat top "Dartmouth Style" with square spindles to match existing. Provided dual top horizontal rail at new 36" height, where noted on elevations at areas of new work.

Utilize stainless steel nails and staples in all related assembly. No exposed screws, plates nor others metal fasteners are to visible. Use of vinyl railing and vinyl railing couplings, end plates, or "rosettes" is not permitted. Use of any screws shall require screw head location to be counter-sunk and plugged with wood or synthetic polymer plugs.

Exterior Window Crowns, Casings & Surrounds: All new ornamental architectural trim, crowns, window, drip and door caps, and articulated door and window surrounds, as shown on the elevations and details, are to be synthetic polymer as manufactured by Azek and be 5/4" in thickness in order to attain proper window and door casing dimensional relief, and be in color as approved by HPC Resolution. New crowns and sills to have one half inch extensions, as per Typical Window Trim Detail. All new porch and overhang soffits to be Azek beaded board.

Porch Lattice Panels: New dimensional lattice panels to be 3-D composite type framed at all perimeter edges with painted Azek material.

Gutters and Leaders:

Contractor to provide new 6 inch aluminum half-round type gutters with outlet and connection to drain as per local requirements to replace all existing or failed gutter conditions. Color to match fascia and corner boards and be approved by Owner and Architect.

Porch Columns and Posts:

New Columns to be turned 6" square load bearing type as manufactured by HB&G or Architect approved equal. Structural and cross framing within the rear gable assembly to be 6" ACQ material clad with Azek facings and wraps and be chamfered at all extended runs as required by HPC.

Bathroom Fixture Fittings and Trim:

All bathroom fixtures, trim kits and fittings to be selected and provided by Owner and installed by Contractor. All bathroom fixture fittings and accessories to be fabricated of solid brass and of same style and series and be of matching finish as selected by Owner.

All bathroom fixtures by Kohler, Memoir Designer Series or equal as selected by Owner. All trim and fittings to be satin nickel finish by Rohl, or equal. All fitting finishes to be selected by Owner. Provide scald proof diverters with thermostatic type valve controls at all shower heads.

Contractor to install double stud on the flat behind grab bar fastening points to attain a 200 pound static load where grab bars, towel bars and paper holders are to be provided.

Medicine Cabinets: All medicine cabinets to the recessed into walls where indicated on plan, and be framed as provided by Owner but

cabinets to maintain insulation continuity.

Division 10 - Specialties All specialty systems are to be established and designed by others but may be included into scope of work by Contractor upon the Owner's request.

installed by Contractor. Any exterior recessed medicine

<u> Internet Access:</u>

Provide all wiring for all TV/Cable locations as required in all locations noted on all floor plans. Refer to electrical floor plans for all locations. Provide flat panel wall boxes (PWB) in proposed wall mounted digital TV flat screen positions. All TV/Cable boxes, wiring, modems or devices for remote operation are installed by Cable TV provider as per Owner.

Provide one new (1) Cat6 Internet hook-up with wireless modem capabilities at to be determined by Owner.

Security system to be provided by others, and as determined and approved by Owner.

Second Floor Fiberglass Porch Deck:

Porch deck to receive two coats fiberglass on 3/4" CDX plywood screwed to structural joist floor framing with aluminum flashing and counter-flashing at building edge. Upper floor porch deck to pitch to drain at 1/8" per foot minimum. Color to complement exterior siding, as approved

attenuation at all interior bedroom walls and floors between all floor levels and the walls at baths where framing cavities

Division 11 - Equipment

Acoustic Treatments:

Kitchen Cabinetry: Kitchen cabinetry to be as per plan with door and hardware style as selected by the Owner. Cabinet fabricator to provide samples and shop drawings for approval prior to manufacture. Contractor to be responsible for coordination of all appliance dimensions with the cabinet fabricator.

Contractor to be responsible for the storage and protection

installed by Contractor. Cooktop Range to be Gas. Wall

Oven, Microwave, Dishwasher, Beverage Center, Icemaker

of all cabinetry delivered to and while stored on site.

Provide open full batt insulation to serve as sound

are exposed or associated with the new construction.

Kitchen Appliances: All appliances to be purchased and supplied by Owner and

and Washer/Dryer to be Electric. **Division 12 - Furnishings**

Not included.

Not included. **Division 13 - Special Construction**

Not included. **Division 14 - Conveying Systems**

Division 15 - Mechanical/Plumbing Existing HVAC Modification:

General Contractor to coordinate all new HVAC systems as required to accommodate proposed renovations. Unless shown on these drawings, all mechanical work such

as, but not limited to heating and air conditioning

engineering, are to be established and designed by others.

Final location of ductwork, returns and equipment are to be

approved by the Owner and Architect. Contractor to provide and install a new direct vent gas fired 3-zone system, and be 90% AFUE to be approved by Owner

prior to purchase of equipment and installation. Contractor to provide Heat Pump System with high velocity ductwork configuration for both heating and cooling

HVAC Zones to be as follows:

Zone 1: First Floor Zone 2: Second Floor Zone 3: Attic Level

Thermostat Controls: Each zone to receive an individual Smart Thermostat as manufactured by "Honeywell" or equal and verified to be

compatible with system and capable of remote monitoring. Air Conditioning:

New air conditioning system to be certified with a minimum SEER of 13, with low db noise emission rating and up-flow design with Neptune Township Zoning Approval. Deviation from specified condenser unit as shown on plans must be submitted for approval by local Zoning Officer.

All supply vents to be either floor or ceiling mounted and shall not be located in perimeter exterior walls unless fully insulated and encapsulated with insulation assembly equivalent to the R value of the Typical Exterior Wall

Section as illustrated in the Construction Documents.

Supply ducts in unconditioned basement and attics are to be insulated with a minimum of R-8. All other ducts are to be insulated with a minimum of R-6 for compliance with the Energy Code.

Duct joints and connections to flanges of air distribution equipment are to be mechanically fastened and sealed. All other joints, seams, and connections are to be securely fastened with welds, gaskets, mastics or tapes. Tapes and mastics to be rated UL 181A or UL 181B.

and final alignment of supply and return diffusers subject to review and approval by Architect and Owner. Contractor to coordinate all placement and connections to all HVAC systems as required and verify positioning of

ductwork so as to be compliant with current Energy Code.

Installation of all new forced air insulated ductwork system

Hot Water Heating:

Contractor to provide and install two (3) new tankless ondemand gas-fired hot water heaters by A.O. Smith or equal, of capacity to adequately service all hot water requirements. General Contractor to provide all venting of laundry dryer,

bathrooms and kitchen, and integrated exhaust fan/ceiling

light units in ceiling of bathrooms and shower enclosures as indicated on plans. New bathroom exhaust fans to be silent (quiet) running 120 cfm minimum as manufactured by Panasonic or equal. Kitchen exhaust to be appropriately sized with a maximum 650 cfm. Kitchen exhaust fans exceeding 650 cfm will require make up air system to be installed by others. New exterior wall exhaust vent covers

to be as per plan and specified and approved by HPC

Water and Sewer Lines:

Contractor to verify adequacy of existing services and include any re-alignment, replacement, re-lining and trenching, when required due to replacement of service.

Contractor to verify adequacy of existing water pressure.

Piping & Plumbing:

All supply lines to be in compliance with Code. Contractor may utilize PVC with acoustical wrap and drop sound deadening interventions. Work to include all required copper piping, fittings and equipment. Use of Pex piping is an acceptable alternate. Scope of work to include supply and installation of all piping, pipe fittings and equipment.

Provide all connections to dishwasher, refrigerator, and other components requiring plumbing hook-up as per proposed scope of work indicated on plans. Contractor to abandon and remove any remaining galvanized water supply piping and replace with new piping.

HVAC piping conveying fluids above 105 degrees F or chilled fluids below 55 degrees F to be insulated with R-3. Contractor to include all copper piping, materials and related fittings and equipment.

Owner to supply all bathroom fixtures, sinks and toilets, kitchen sink, laundry sink, washer, dryer and all related faucets, towel bars, paper holders, robe hooks, medicine cabinets and related items for installation by Contractor.

New Laundry Area Floor Pan and Drain: Install floor drain under washer in laundry area.

Division 16 – Electrical

Unless shown on these drawings, all electrical work such as, but not limited to hot water heating, related plumbing, air conditioning or other ventilating systems are to be connected to service and service panels by Contractor.

Electrical Service:

Contractor to verify existing electrical service prior to preparing an application for construction permit. Contractor confirm and provide a minimum 200 Amp Electrical Service. Panel schematics to be prepared and filed for permit by Electrical Subcontractor.

Electrical HVAC Connections: Contractor to provide all electrical hook-up as indicated on plans including HVAC equipment.

Electrical Wiring and Requirements: Contractor to install all new circuits and services as schematically indicated on the drawings. Prior to installation, the Owner, Electrical Contractor and Architect are to review all switch, receptacle, recessed and surface

All new wires to be concealed constructed of copper with thermoplastic insulation and sized in accordance with Code.

All switches, outlets and other devices shall be appropriate

mounted fixture locations for final approval.

for their intended use with UL Certification. Unless otherwise noted, all switches shall be mounted at standard 4'-2" height above finished floor. GFI's to be

Provide and install dimmer switch controls where indicated

on electrical schematic plans. All electrical wall switches to be rocker type, or as otherwise requested by Owner. **Lighting Fixtures:**

provided where required by Code and noted on plans.

All surface mounted fixtures to be supplied by the Owner and installed by the Contractor. All new recessed LED lighting to be maximum of 5" aperture with white trim kits and reflectors. Provide 4" aperture lighting housings over kitchen counter areas as

noted on electrical plans. All under cabinet or in cabinet lighting to be supplied by Contractor to match cabinet color and be approved by Owner prior to installation. Under cabinet lighting to include linear convenience receptacle strip. All recessed lighting to

be as manufactured by Halo or Architect approved equal,

Paddle Ceiling Fans: Any new paddle ceiling fans to be supplied by Owner and installed by the Contractor.

Electrical Life-safety System Connections:

the floor plans.

Exterior Lighting Compliance Note: All new exterior lighting to comply with Section 402 of the Neptune Township Land Use Ordinance for illumination levels and potential impact onto adjacent properties.

Carbon Monoxide and Smoke Detection Alarms to be provided at each floor level in common hallways within the adjacency of all sleeping areas and within 10 feet of all bedroom entry doors, as required by Code and indicated on

> **SEER Heat Pump** GSZ140241, Upflow. Downflow, Horizontal Air Handler ARUF25B14 Brand: Goodman

Goodman 2 Ton 14

ISSUES Description Date 2 HPC COMMENTS slinn & LOZI IECK VIDATE Mark Alexander Pavliv, AIA

77 Main Avenue, Suite 101

(732) 776 - 8777NJ Lic No. AI00820300 springlakearchitect.com mp77aia@aol.com

Proposed Renovations & Rear Addition to the

Block #115, Lot #6 Use Group: R5 **Construction Type: 5B**

O'Connor Residence 7 Ocean Pathway Ocean Grove, NJ

Specifications

As Noted 2022990075 DRAWING No. 1/31/23 **A8** DRAWN, BY

Up-flow AC Condenser Unit Scale: NTS

REVISIONS

Date

6/12/29

Description

\$200 IECC UPDATE

V HPG COMMENSTES

Ocean Grove, NI 07756

Existing 2 1/2 Story **Wood Frame** Single-Family Dwelling

PROJECT NAME

DRAWING TITLE

MP/CP CHECKED BY



Construction Type:

Generated by REScheck-Web Software

7 OCEAN PATHWAY, OCEAN GROVE - ADDITION

Energy Code: 2021 IECC Location: Ocean Grove, New Jersey

Project Type: Orientation: Bldg. faces 135 deg. from North Climate Zone: 4 (5253 HDD)

Single-family

Permit Date: Permit Number: Construction Site:

7 OCEAN PATHWAY OCEAN GROVE, NJ, NJ 07756

Owner/Agent: TERRIE O'CONNOR 7 OCEAN PATHWAY Ocean Grove, New Jersey 07756 terrie@tocr.com,

Designer/Contractor: MARK PAVLIV Mark Alexander Pavliv, AIA 77 MAIN AVENUE, SUITE 101 OCEAN GROVE, New Jersey 07756 MP77AIA@AOL.COM

ompliance: Passes using UA trade-off Compliance: 0.0% Better Than Code Maximum UA: 180 Your UA: 180 Maximum SHGC: 0.40 Your SHGC: 0.25 The % Better or Worse Than Code Index reflects how close to compliance the house is based on code trade-off rules. It DOES NOT provide an estimate of energy use or cost relative to a minimum-code home.

Slab-on-grade tradeoffs are no longer considered in the UA or performance compliance path in REScheck. Each slab-on-grade assembly in the specified climate zone must meet the minimum energy code insulation R-value and depth requirements.

Envelope Assemblies

Assembly	Gross Area or Perimeter	Cavity R-Value	Cont. R-Value	Prop. U-Factor	Req. U-Factor	Prop. UA	Req. UA
Ceiling: Flat Ceiling or Scissor Truss	455	60.0	2.2	0.022	0.024	10	11
Wall: Wood Frame, 16" o.c. Orientation: Unspecified	1,643	21.0	2.5	0.049	0.045	71	65
Window: Wood Frame SHGC: 0.27 Orientation: Unspecified	194			0.310	0.300	60	58
Floor: All-Wood Joist/Truss	455	30.0	2.2	0.030	0.047	14	21
Door: Glass Door (over 50% glazing) SHGC: 0.21 Orientation: Unspecified	82			0.310	0.300	25	25 ·

Additional Efficiency Package(s) Not applicable

Compliance Statement: The proposed building design described here is consistent with the building plans, specifications, and other calculations submitted with the permit application. The proposed building has been designed to meet the 2021 IECC requirements in REScheck Version: REScheck-Web and to comply with the mandatory requirements listed in the REScheck Inspection Checklist.

PROPOSED 2 1/2 STORY ADDITION TO AN EXISTING LANDMARK SINGLE-FAMILY RESIDENCE

REScheck Software Version : REScheck-Web

Inspection Checklist

Energy Code: 2021 IECC

Requirements: 97.0% were addressed directly in the REScheck software Text in the "Comments/Assumptions" column is provided by the user in the REScheck Requirements screen. For each requirement, the user certifies that a code requirement will be met and how that is documented, or that an exception is being claimed. Where compliance is itemized in a separate table, a reference to that table is provided.

Section # & Req.ID	Pre-Inspection/Plan Review	Plans Verified Value	Field Verified Value	Complies?	Comments/Assumptions
103.1, 103.2 [PR1] ¹	Construction drawings and documentation demonstrate energy code compliance for the building envelope. Thermal envelope and energy compliance path represented on construction documents.			□Complies □Does Not □Not Observable □Not Applicable	Requirement will be met. Location on plans/spec: A6, A7. A8
103.1, 103.2, 403.8 [PR3] ¹	Construction drawings and documentation demonstrate energy code compliance for lighting and mechanical systems. Systems serving multiple dwelling units must demonstrate compliance with the IECC Commercial Provisions.			□Complies □Does Not □Not Observable □Not Applicable	Requirement will be met. Location on plans/spec: A6, A7, A8, A9
302.1, 403.7 [PR2] ²	Heating and cooling equipment is sized per ACCA Manual S based on loads calculated per ACCA Manual J or other methods approved by the code official.	Heating: Btu/hr Cooling: Btu/hr	Heating: Btu/hr Cooling: Btu/hr	□Complies □Does Not □Not Observable □Not Applicable	Requirement will be met. Location on plans/spec: A9

Additional Comments/Assumptions:

Section # & Req.ID	Foundation Inspection	Complies?	Comments/Assumptions
303.2.1 [FO11] ²	A protective covering is installed to protect exposed exterior insulation and extends a minimum of 6 in. below grade.	□Complies □Does Not □Not Observable □Not Applicable	Exception: Requirement is not applicable.
403.9 [FO12] ²	Snow and ice-melting system controls installed to shut off system when pavement temperature > 50F and no precipitation.	□Complies □Does Not □Not Observable □Not Applicable	Exception: Requirement is not applicable.

Additional Comments/Assumptions:

Section #	Framing / Rough-In Inspection	Plans Verified Value	Field Verified Value	Complies?	Comments/Assumptions
& Req.ID 102.1, 102.3.1, 102.3.3, 102.5 FR2] ¹	Glazing U-factor (area-weighted average).	U	U	☐Complies ☐Does Not ☐Not Observable ☐Not Applicable	See the Envelope Assemblies table for values.
303.1.3 FR4] ¹	U-factors of fenestration products are determined in accordance with the NFRC test procedure or taken from the default table.			Complies Does Not Not Observable Not Applicable	Requirement will be met. Location on plans/spec: A5
102.4.1.1 FR23] ¹	Air barrier and thermal barrier installed per manufacturer's instructions.			☐Complies ☐Does Not ☐Not Observable ☐Not Applicable	Requirement will be met. Location on plans/spec: A5, A6, A7, A8
102.4.3 FR20]¹ ⊌	Fenestration that is not site built is listed and labeled as meeting AAMA /WDMA/CSA 101/I.S.2/A440 or has infiltration rates per NFRC 400 that do not exceed code limits.			□Complies □Does Not □Not Observable □Not Applicable	Requirement will be met.
102.4.5 FR16] ²	IC-rated recessed lighting fixtures sealed at housing/interior finish and labeled to indicate ≤2.0 cfm leakage at 75 Pa.			□Complies □Does Not □Not Observable □Not Applicable	Requirement will be met. Location on plans/spec: A7, A8, E1
03.3.1 FR12] ¹	Supply and return ducts in attics insulated >= R-8 where duct is >= 3 inches in diameter and >= R-6 where < 3 inches.			□Complies □Does Not □Not Observable □Not Applicable	Requirement will be met. Location on plans/spec: A8, A9
03.3.4 FR13] ¹	Ducts, air handlers and filter boxes are sealed with joints/seams compliant with International Mechanical Code or International Residential Code, as applicable.			□Complies □Does Not □Not Observable □Not Applicable	Requirement will be met. Location on plans/spec: A8, A9
.03.3.7 FR15] ³	Building cavities are not used as ducts or plenums.			□Complies □Does Not □Not Observable □Not Applicable	Requirement will be met. Location on plans/spec: A8, A9
FR28] ³ 	Ducts declared to be within the conditioned space are either 1) completely within the continuous air barrier and within the building thermal envelope, 2) buried within ceiling insulation in accordance with Section R403.3.6 and the air handler is located completely within the continuous air barrier and within the building thermal envelope and the duct leakage is <= 1.5 cfm / 100 square feet of conditioned floor area served by the duct system, or 3) the ceiling insulation R-value installed against and above the insulated duct >= to the proposed ceiling insulation R-value, less the R-value of the insulation on the			□Complies □Does Not □Not Observable □Not Applicable	Requirement will be met. Location on plans/spec: A8, A9
Section # & Req.ID	Framing / Rough-In Inspection	Plans Verified Value	Field Verified Value	Complies?	Comments/Assumptions
	HVAC piping conveying fluids above 105 °F or chilled fluids below 55 °F are insulated to >P.	R	R	□Complies □Does Not	Requirement will be met.

# & Req.ID	Framing / Rough-In Inspection	Plans Verified Value	Field Verified Value	Complies?	Comments/Assumptions
403.4 [FR17] ²	HVAC piping conveying fluids above 105 °F or chilled fluids below 55 °F are insulated to ≥R- 3.	R	R	□Complies □Does Not □Not Observable □Not Applicable	Requirement will be met. Location on plans/spec: A8, A9
403.4.1 [FR24]¹ ❷	Protection of insulation on HVAC piping.			□Complies □Does Not □Not Observable □Not Applicable	Requirement will be met. Location on plans/spec: A8, A9
402.4.6 [FR29] ³	Electrical and communication boxes installed in the thermal boundary of the envelope sealed to limit air leakage between conditioned and unconditioned spaces.			□Complies □Does Not □Not Observable □Not Applicable	Requirement will be met. Location on plans/spec: A8, E1
403.5.2 [FR18] ²	Hot water pipes are insulated to ≥R-3.	R	R	☐Complies ☐Does Not ☐Not Observable ☐Not Applicable	Requirement will be met. Location on plans/spec: A8, A9
403.6 [FR19] ²	Automatic or gravity dampers are installed on all outdoor air intakes and exhausts for mechanical ventilation systems.			☐Complies ☐Does Not ☐Not Observable ☐Not Applicable	Requirement will be met. Location on plans/spec: A8
403.6.1 [FR30] ²	Ventilation systems in climate zones 7 & 8 shall utilize heat or energy recovery			☐Complies ☐Does Not ☐Not Observable ☐Not Applicable	Requirement will be met. Location on plans/spec: NOT APPLICABLE IN ZONE 4

Section # & Req.ID	Insulation Inspection	Plans Verified Value	Field Verified Value	Complies?	Comments/Assumptions
303.1 [IN13] ²	All installed insulation is labeled or the installed R-values			□Complies □Does Not	Requirement will be met.
e provided.				□Not Observable □Not Applicable)) (1) (2) (3) (4) (5) (6) (7) (7) (7) (7) (7) (7) (7) (7) (7) (7
402.1, 402.2.7	Floor insulation R-value.	R ☐ Wood	R ☐ Wood	□Complies □Does Not	See the Envelope Assemblies table for values.
[IN1] ¹ (a)		☐ Steel	☐ Steel	□Not Observable □Not Applicable	
402.2.5,	Wall insulation R-value. If this is a mass wall with at least ½ of the wall insulation on the wall exterior, the exterior insulation requirement applies (FR10).	R Wood Mass Steel	R Wood Mass Steel	□Complies □Does Not □Not Observable □Not Applicable	See the Envelope Assemblies table for values.
	Wall insulation is installed per manufacturer's instructions.			□Complies □Does Not □Not Observable □Not Applicable	Location on plans/spec: A6, A7. A8

Additional Comments/Assumptions:

# & Req.II		Plans Verified Value	Field Verified Value	Complies?	Comments/Assumptions
402.1, 402.2.1, 402.2.2, 402.2.6 [FI1] ¹	Ceiling insulation R-value.	R Wood Steel	R Wood Steel	□Complies □Does Not □Not Observable □Not Applicable	See the Envelope Assemblies table for values.
303.1.1.1 303.2 [FI2] ¹	, Ceiling insulation installed per manufacturer's instructions. Blown insulation marked every 300 ft ² .			□Complies □Does Not □Not Observable □Not Applicable	Requirement will be met. Location on plans/spec: A6, A7, A8
402.2.3 [Fl22] ²	Vented attics with air permeable insulation include baffle adjacent to soffit and eave vents that extends over insulation.			☐Complies ☐Does Not ☐Not Observable ☐Not Applicable	Requirement will be met. Location on plans/spec: A6, A7, A8
402.2.4 [FI3] ¹	Attic access hatch and door insulation ≥R-value of the adjacent assembly.	R	R	☐Complies ☐Does Not ☐Not Observable ☐Not Applicable	Requirement will be met. Location on plans/spec: A7, A8
402.4.1.3 [FI17] ¹	Blower door test @ 50 Pa. <=5.0 ach in Climate Zones 1-2, and <=3.0 ach in Climate Zones 3-8.	ACH 50 =	ACH 50 =	□Complies □Does Not □Not Observable □Not Applicable	Requirement will be met. Location on plans/spec: A8
403.3.5 [FI27] ¹	Ducts are pressure tested in accordance with ANEI/RESNET/ICC 380 or ASTME1554 to determine air leakage with either: Rough-in test: Total leakage measured with a pressure differential of 0.1 inch w.g. across the system including the manufacturer's air handler enclosure if installed at time of test. Postconstruction test: Total leakage measured with a pressure differential of 0.1 inch w.g. across the entire system including the manufacturer's air handler	cfm/100 ft ²	cfm/100 ft ²	□Complies □Does Not □Not Observable □Not Applicable	Requirement will be met. Location on plans/spec: A8, A9
403.3.6 [FI4] ¹	enclosure. Duct tightness test result of <=4 cfm/100 ft2 across the system or <=3 cfm/100 ft2 without air handler @ 25 Pa. Duct tightness <= 8 cfm/100 ft2 for ducts within thermal envelope. For rough-in tests, verification may need to occur during Framing Inspection.	cfm/100	cfm/100 ft ²	□Complies □Does Not □Not Observable □Not Applicable	Requirement will be met. Location on plans/spec: A8, A9
403.3.4.1 [FI24] ¹	by manufacturer at <=2% of design air flow.			□Complies □Does Not □Not Observable □Not Applicable	Requirement will be met. Location on plans/spec: A9
403.1.1 [FI9] ²	Programmable thermostats installed for control of primary heating and cooling systems and initially set by manufacturer to code specifications.			□Complies □Does Not □Not Observable □Not Applicable	Requirement will be met. Location on plans/spec: A8, A9
403.5.1 [FI11] ²	Circulating service hot water systems have automatic or accessible manual controls.			□Complies □Does Not □Not Observable □Not Applicable	Requirement will be met. Location on plans/spec: A8, A9
Section #	Final Inspection Provisions	Plans Verified Value	Field Verified Value	Complies?	Comments/Assumptions
& Req.ID 103.2 FI26] ²	Hot water boilers supplying heat through one- or two-pipe heating systems have automatic outdoor setback control to lower boiler water temperature based on outdoor temperature, indoor temperature or water		Value	□Complies □Does Not □Not Observable □Not Applicable	Exception: Requirement is not applicable.
.03.5.1.1 FI28] ²	Heated water circulation systems have a circulation pump. The system return pipe is a dedicated return pipe or a cold water supply pipe. Gravity and thermossyphon circulation systems are not present. Controls for circulating hot water system pumps start the pump with signal for hot water demand within the occupancy. Controls automatically turn off the pump when water is in circulation loop is at set-point temperature and			□Complies □Does Not □Not Observable □Not Applicable	Exception: Requirement is not applicable.
03.5.1.2 FI29] ²	no demand for hot water exists. Electric heat trace systems comply with IEEE 515.1 or UL 515. Controls automatically adjust the energy input to the heat tracing to maintain the desired water temperature in the			□Complies □Does Not □Not Observable □Not Applicable	Exception: Requirement is not applicable.
.03.5.3 FI31] ²	piping. Drain water heat recovery units tested in accordance with CSA B55.1. Potable water-side pressure loss of drain water heat recovery units < 3 psi for individual units connected to one or two showers. Potable water-side pressure loss of drain water heat recovery units < 2 psi for individual units connected to three or more showers.			□Complies □Does Not □Not Observable □Not Applicable	Exception: Requirement is not applicable.
03.6.2 FI25] ²	All mechanical ventilation system fans not part of tested and listed HVAC equipment meet efficacy and air flow limits per Table R403.6.2.			□Does Not	Requirement will be met. Location on plans/spec: A9
03.6.3 -[33] ²	Mechanical ventilation systems tested and verified to meet the minimum flow rates required by Section R403.6.			□Does Not □Not Observable □Not Applicable	Requirement will be met. Location on plans/spec: A6, A9, A9
03.5.1.1. FI32] ² 04.1	Demand recirculation water systems have automatic controls to start pump when hot water is requested. 100% of permanent fixtures have			□Does Not □Not Observable □Not Applicable	Exception: Requirement is not applicable. Requirement will be met.
04.1.2	high efficacy lamps. Fuel gas lighting systems have			□Does Not □Not Observable □Not Applicable	Location on plans/spec: A8, A9, E2 Requirement will be met.
FI23] ³	no continuous pilot light.			Does Not	Location on plans/spec: A9
# Req.ID 04.1.1 =135] ³	Exterior lighting for multifamily buildings shall comply with Section C405.4.	Plans Verified Value]]	Does Not Not Observable	Comments/Assumptions Exception: Detached one- and two- family dwellings.
-136] ³ 	Permanent interior lighting shall be controlled with either a dimmer, occupancy sensor or other control built into the fixture.) 	Does Not	Requirement will be met. Location on plans/spec: A9, E2
04.3 137] ³	Exterior lighting >= 30 watts shall have the following controls: manual on/off switch with automatic shut-off, automatic shut-off in daylight hours, and controls that override automatic shutoff that returns to automatic control within 24 hours.		[[[Complies Does Not	Requirement will be met. Location on plans/spec: A8. A9, E2
01.3 [7] ²	Compliance certificate posted with building specifications and compliance path and results.		[C	□Complies □Does Not □Not Observable □Not Applicable	Requirement will be met.
	Manufacturer manuals for	e de la como de la figura de Andrea. La figura de la fig	_		Requirement will be met.



Water Heater:		
Cooling System:		
Heating System:		
Heating & Cooling Equipment	Efficiency	
Door	0.31	0.2
Window	0.31	0.2
Glass & Door Rating	U-Factor	SHC
Ductwork (unconditioned spaces)	<u> </u>	
Ceiling / Roof	62.23	
Floor	32.23	
Below-Grade Wall	0.00	
Above-Grade Wall	23.47	
nsulation Rating	R-Value	


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77 Main Avenue, Suite 101 Ocean Grove, NJ 07756

(732) 776 - 8777NJ Lic No. AI00820300 springlakearchitect.com mp77aia@aol.com




Proposed Renovations & Rear Addition to the Existing 2 1/2 Story **Wood Frame** Single-Family Dwelling Block #115, Lot #6 Use Group: R5 **Construction Type: 5B**

PROJECT NAME	
O'Connor	Residence
7 Ocean P	athway
Ocean Gro	•
DRAWING TITLE	
REScheck	
Energy Co	mnliance
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SCALE	JOB No.
As Noted	2022990078
DATE /31/23	DRAWING No.
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Exterior Lighting Compliance Note: All new exterior lighting to comply with Section 402 of the Neptune Township Land Use Ordinance for illumination levels and potential impact onto adjacent properties.

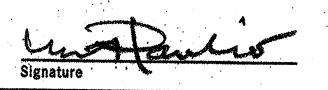Smoke and Carbon Monoxide Detection: Provide interconnected 110v smoke detector in accordance with IRC 2021 New Jersey Edition - as indicated on all floor plans. Smoke and Carbon Monoxide detection devices to be provided within vicinity of each sleeping area and no further than 10 feet from outside (entry door) of each bedroom.



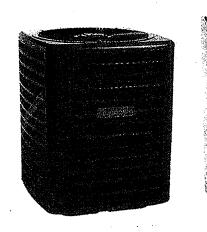

Goodman 2 Ton 14 SEER Heat Pump GSZ140241, Upflow, Downflow, Horizontal Air Handler ARUF25B14 Brand: Goodman

Up-flow AC Condenser Unit Scale: NTS

Legend

VEW WINDOW LOCATION EXISTING DOOR TO REMAIN EXISTING DOOR TO BE REMOVED

NEW WOOD STUDS WALLS EXISTING WINDOW LOCATION

NEW CONCRETE FOOTING AND FOUNDATION

ROOF OVERHANG OR SOFFIT LINE

ELEC. 3 WAY SWITCH

ELEC. WALL OUTLET ELEC. FLOOR OUTLET

ELEC. HALF-HOT WALL OUTLET


CEILING MOUNTED LIGHT BRACKET/WALL MOUNTED LIGHT


RECESSED CEILING LIGHT RECESSED DIRECTIONAL LIGHT

EXHAUST FAN/HEAT LAMP

SMOKE DETECTOR TV/CABLE JACK

TELEPHONE JACK

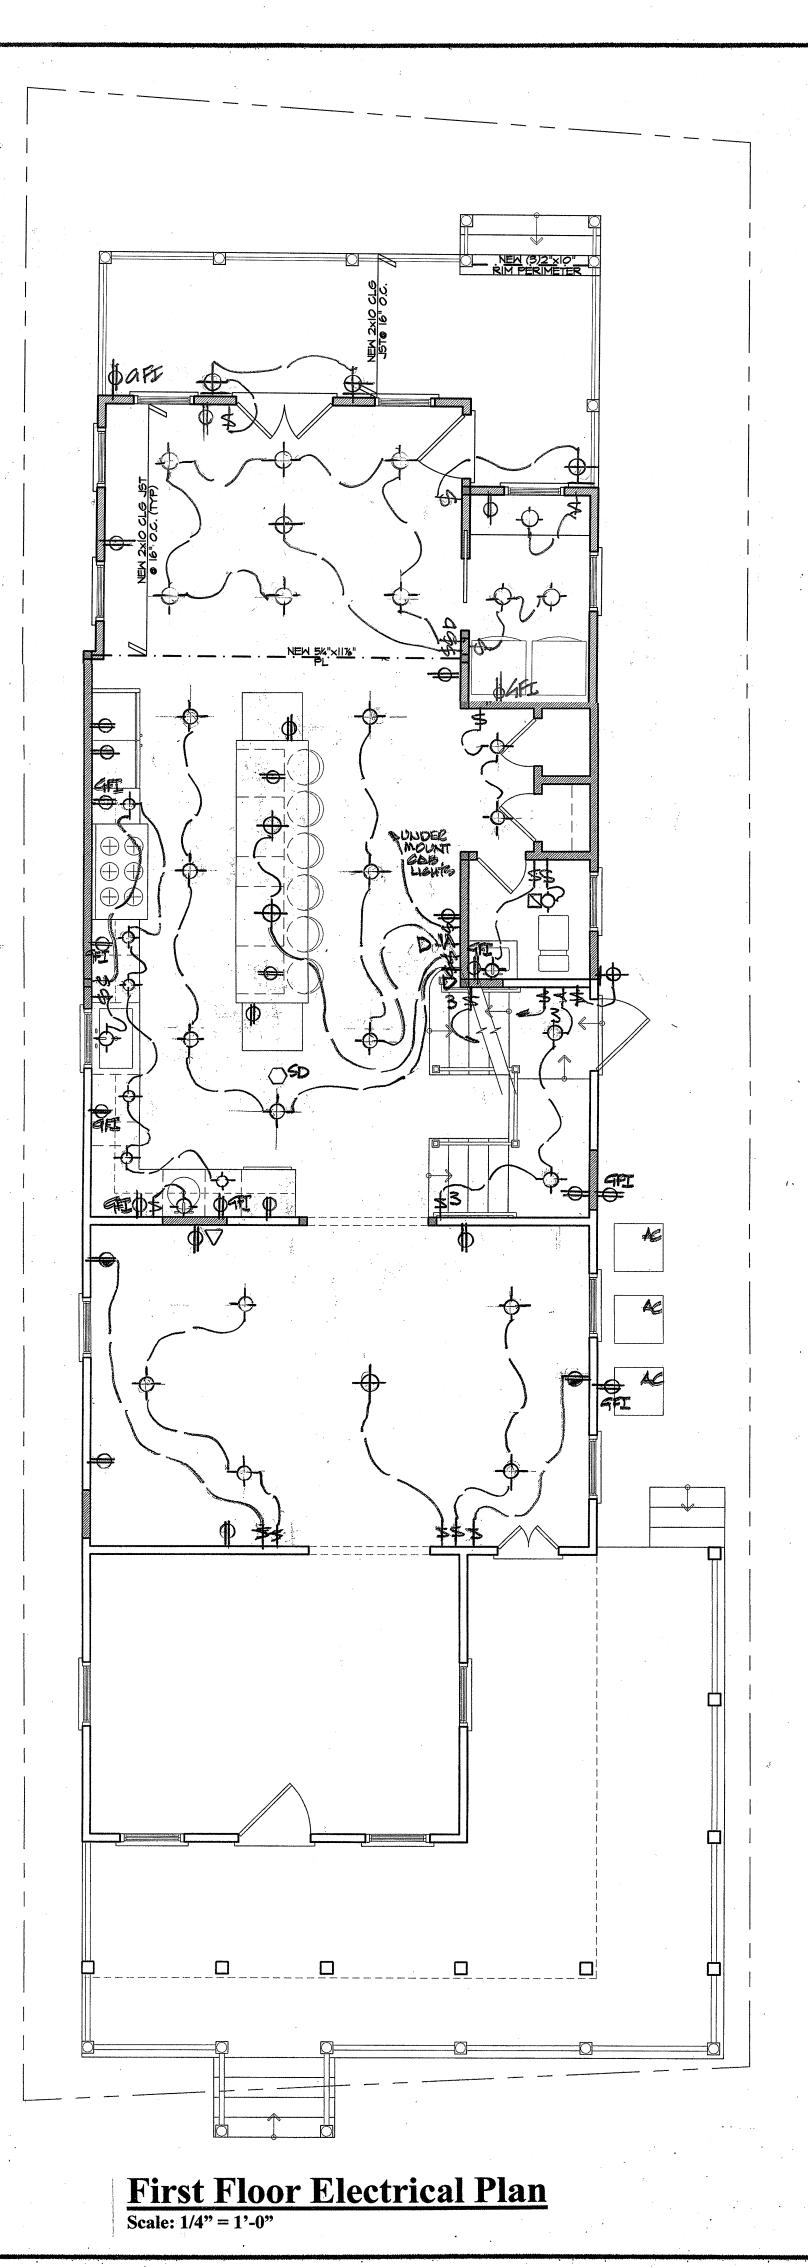

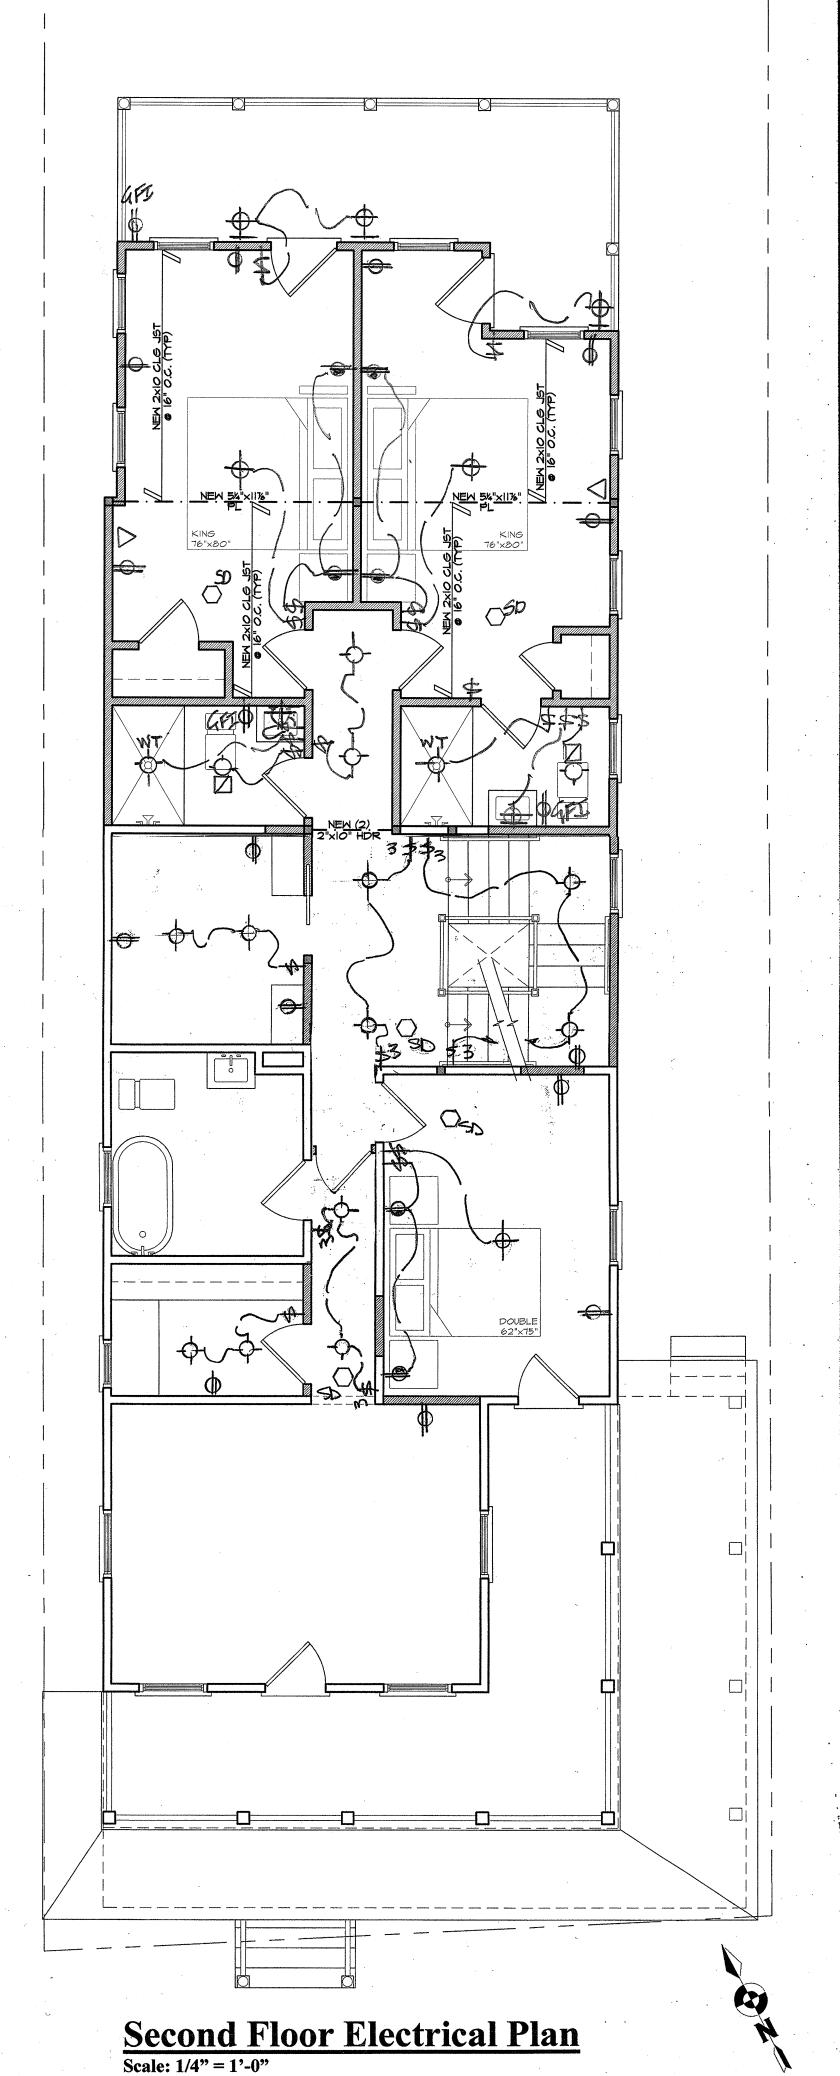


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Mark Alexander Pavliv, AIA

77 Main Avenue, Suite 101 Ocean Grove, NJ 07756

(732) 776 - 8777NJ Lic No. AI00820300 springlakearchitect.com mp77aia@aol.com



Proposed Renovations & Rear Addition to the **Existing 2 1/2 Story Wood Frame Single-Family Dwelling** Block #115, Lot #6

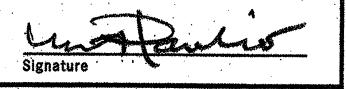Use Group: R5 **Construction Type: 5B**

PROJECT NAME O'Connor Residence 7 Ocean Pathway

Ocean Grove, NJ

DRAWING TITLE First & Second Floor Electrical

SCALE
As Noted JOB No. 2022990075 DATE 1/31/23 DRAWING No. DRAWN BY CHECKED BY

Specification

Division 16 – Electrical

Unless shown on these drawings, all electrical work such as, but not limited to hot water heating, related plumbing, air conditioning or other ventilating systems are to be connected to service and service panels by Contractor.

Electrical Service:

Contractor to verify existing electrical service prior to preparing an application for construction permit. Contractor confirm and provide a minimum 200 Amp Electrical Service. Panel schematics to be prepared and filed for permit by Electrical Subcontractor.

Electrical HVAC Connections:

Contractor to provide all electrical hook-up as indicated on plans including HVAC equipment.

Electrical Wiring and Requirements:

Contractor to install all new circuits and services as schematically indicated on the drawings. Prior to installation, the Owner, Electrical Contractor and Architect are to review all switch, receptacle, recessed and surface mounted fixture locations for final approval.

All new wires to be concealed constructed of copper with thermoplastic insulation and sized in accordance with Code.

All switches, outlets and other devices shall be appropriate for their intended use with UL Certification.

Unless otherwise noted, all switches shall be mounted at standard 4'-2" height above finished floor. GFI's to be provided where required by Code and noted on plans.

Provide and install dimmer switch controls where indicated on electrical schematic plans. All electrical wall switches to be rocker type, or as otherwise requested by Owner.

Lighting Fixtures:

All surface mounted fixtures to be supplied by the Owner and installed by the Contractor.

All new recessed LED lighting to be maximum of 5" aperture with white trim kits and reflectors. Provide 4" aperture lighting housings over kitchen counter areas as noted on electrical plans.

All under cabinet or in cabinet lighting to be supplied by Contractor to match cabinet color and be approved by Owner prior to installation. Under cabinet lighting to include linear convenience receptacle strip. All recessed lighting to be as manufactured by Halo or Architect approved equal,


Paddle Ceiling Fans:
Any new paddle ceiling fans to be supplied by Owner and installed by the Contractor.

Exterior Lighting Compliance Note:

All new exterior lighting to comply with Section 402 of the Neptune Township Land Use Ordinance for illumination levels and potential impact onto adjacent properties.

Electrical Life-safety System Connections:

Carbon Monoxide and Smoke Detection Alarms to be provided at each floor level in common hallways within the adjacency of all sleeping areas and within 10 feet of all bedroom entry doors, as required by Code and indicated on

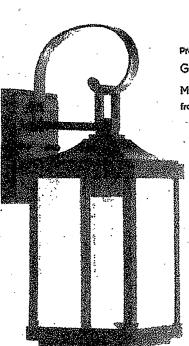


Sibbes Street 15" Tall Outdoor Wall Sconce


Exterior Light Fixture

Exterior Lighting Compliance Note: All new exterior lighting to comply with Section 402 of the Neptune Township Land Use Ordinance for illumination and potential impact onto adjacent properties.

Smoke and Carbon Monoxide Detection: Provide interconnected 110v smoke detector in accordance with IRC 2021 New Jersey Edition - as indicated on all floor plans. Smoke and Carbon Monoxide detection devices to be provided within vicinity of each sleeping area and no further than 10 feet from outside (entry door) of each bedroom.

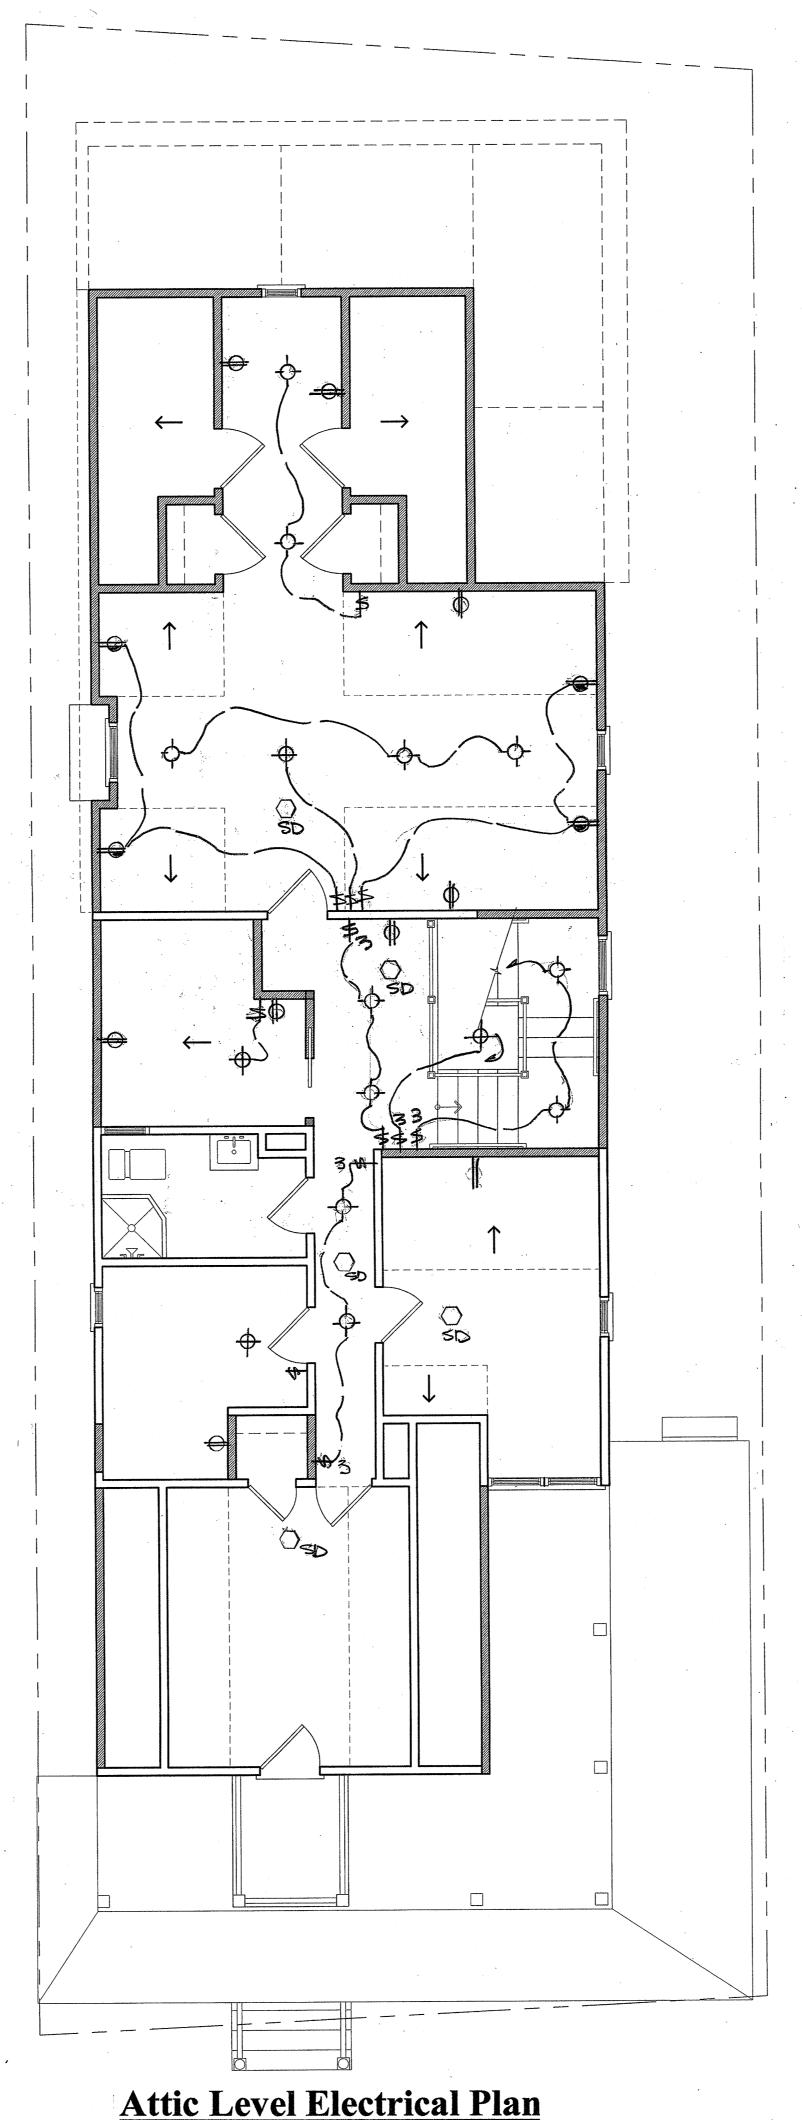

Scale: 1/4" = 1'-0"

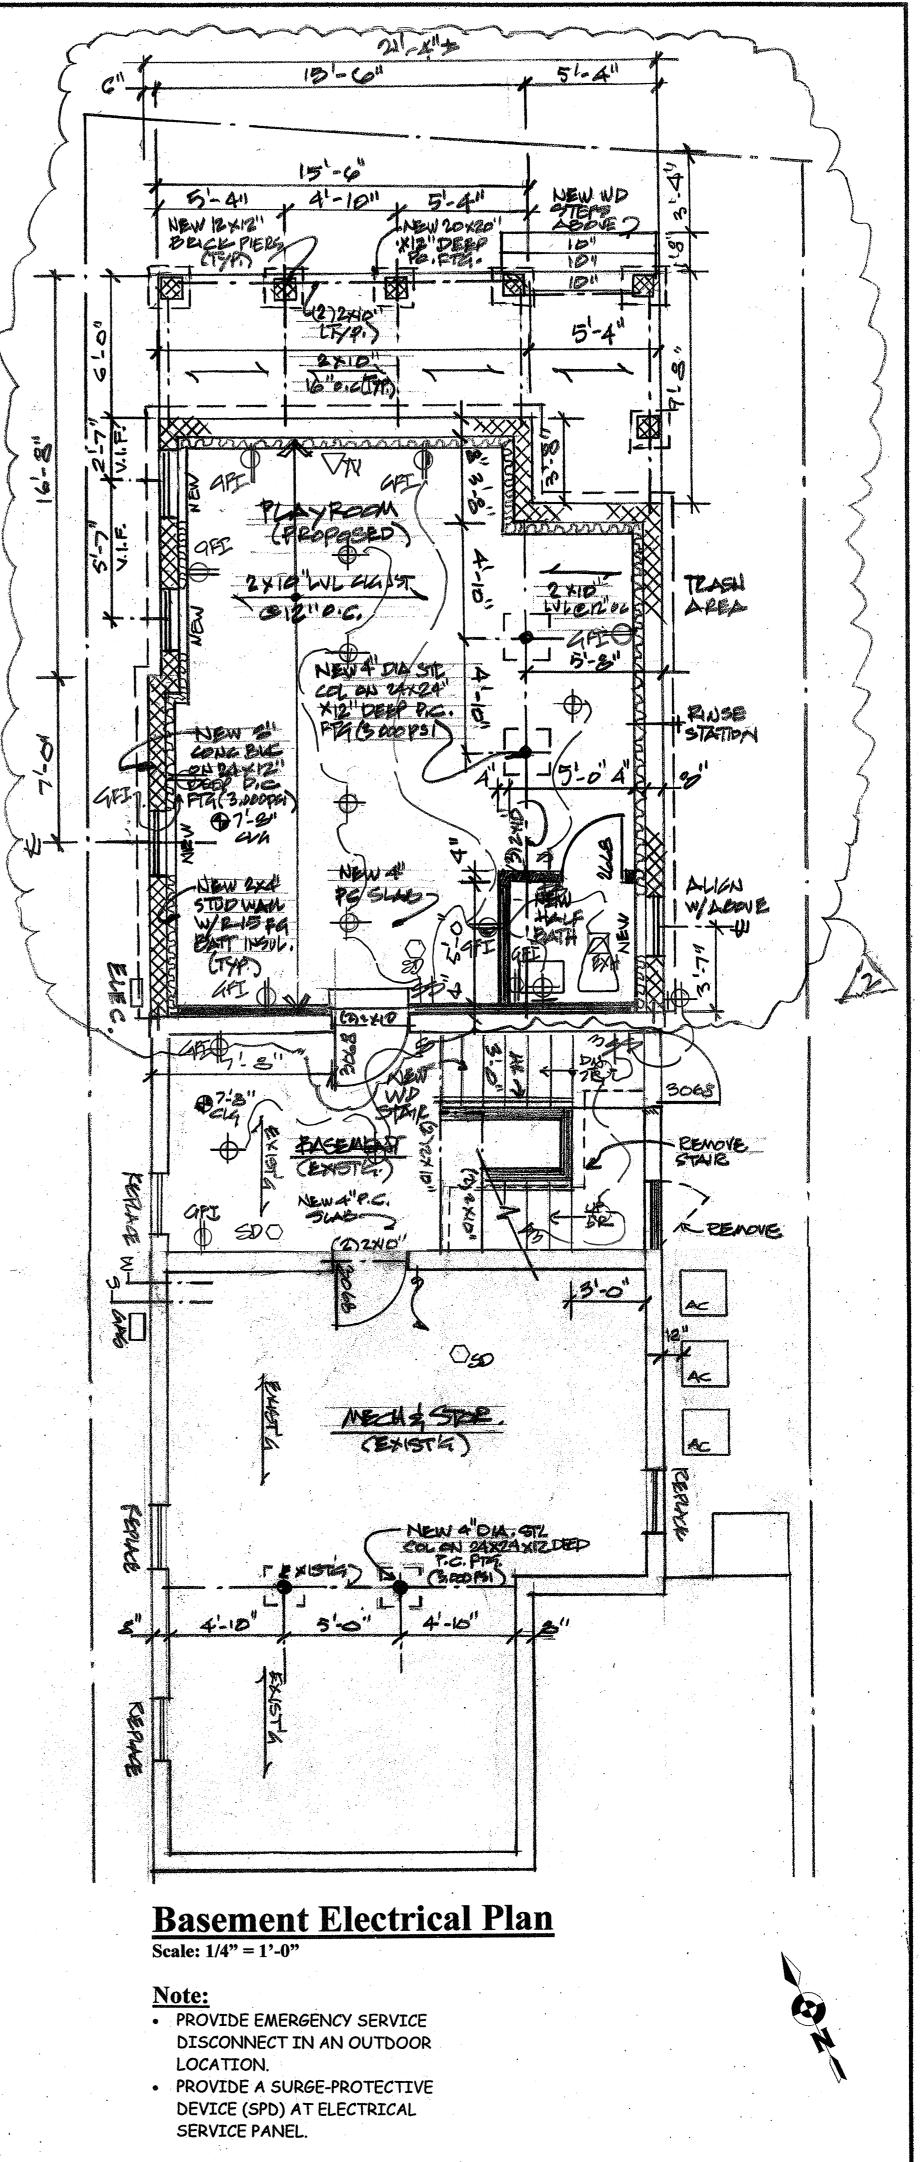


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Proposed Renovations & Rear Addition to the **Existing 2 1/2 Story Wood Frame Single-Family Dwelling** Block #115, Lot #6 Use Group: R5 **Construction Type: 5B**

PROJECT NAME

O'Connor Residence 7 Ocean Pathway Ocean Grove, NJ

DRAWING TITLE

Attic Level Electrical Plan & Specifications

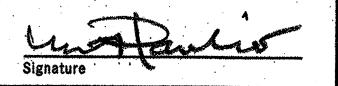As Noted 2022990078 DRAWING No. 1/31/23 EKMPLA CHECKED BY