


Application #: HPC		Application Date:
	Historic Preservation Com	mission
Certif	ficate of Appropriatenes	s Application
☐ AC UNIT	☐ GATE	■ RAILINGS
☐ ADDITION	☐ GENERATOR	☐ RETAINING WALL
☐ ARBOR	☐ GUTTERS & LEADERS	□ ROOF
☐ AWNING	☐ HOT TUB	□ SATELLITE DISH
BALCONY	LATTICE	SHED
☐ CHIMNEY	LIGHT FIXTURE	☐ SHUTTERS
■ COLUMNS	□ NEW CONSTRUCTION	■ SIDING
□ DECK	ORNAMENTATION	☐ SIGN
□ DOOR REPLACEMENT	OUTDOOR SHOWER	☐ SKYLIGHT
☐ DRIVEWAY	☐ PAINT	☐ SOLAR
☐ EXTERIOR ALTERATIONS	☐ PATIO	STAIRS
☐ FENCE	PIERS	☐ VENT
☐ FLAGS / BANNERS	■ PORCH	☐ WALKWAY
☐ FOUNDATION	☐ PORCH FAN	WINDOWS
OTHER		
or any other useful references for re	eview. Once your application is scheduled your application and other submitted docu	o submit color photos of the property, and material samples, color samples, catalog cuts, d for a meeting, you may be required to submit uments.
BLOCK: 209	LOT: <u>13</u>	OUALIE
OWNER INFORMATION NAME(S): MICHAEL HARRIGAN ADDRESS: 59 HECK AVENU PHONE:	E, OCEAN GROVE, NJ 07756	QUALIFIER:
APPLICANT INFORMATION —		,
☐ Check if same as Owner		
	P. Ara	
NAME(S): Mark Alexander Pay	vliv, AIA COMPANY: The	Architect's Studio
ADDRESS: 77 MAIN AVE, SU	ITE 101, OCEAN GROVE, NJ 07	756
PHONE: 732-776-8777	EMAIL: mp77aia@a	ol.com
APPLICANT CAPACITY - IF OTH		
	☐ Contractor ☐ Attorney ☐ Other: _	


PROPERTY TYPE (Charles and Charles and Cha	
PROPERTY TYPE (Check one):	
■ Single Family □ Multifamily: Units □ Commercial □	Condo Mixed Use
ARCHITECTURAL PERIOD / YEAR BUILT: 1953 ARCHITE	CTURAL STYLE: MODERN ERA RANCH
Does your project include demolition of 15% or more of exterior of If YES: you must apply for a Demolition Permit prior to applying for	of existing structure? DVES = NO
Do you have Zoning Department approval for this project? ■ YES ZONING PERMIT ID# (from Zoning Permit): 557348834 Please Note: If Zoning approval is required for the work describe incomplete until Zoning approval is received. Incomplete applications	DATE APPROVED: 4/5/22
Describe all proposed work to be conducted on subject proposed materials to be used. Attach additional pages if necessary. FRONT ELEVATION ASBESTOS SIDING TO BE REPLACED WITH 7" EXPANDICANT REQUESTS APPROVALED THE WIDENING OF THE	OSURE NUCEDAR SHAKES IN EIRST DHASE
APPLICANT REQUESTS APPROVAL FOR THE WIDENING OF THE	E EXISTING 5X14 FT COVERED FRONT
PORCH TO THE FULL WIDTH OF THE CURRENT 24 FT FRONT F.	ACADE AT THIS MODERN ERA 1953
1-STORY WOOD FRAME DWELLING. WORK TO INCLUDE REMO	VAL OF THE EXISTING FRONT BRICK
AND EAST SIDE ALLEY POURED CONCRETE STEPS AND ALUM	INUM RAILING,AND REMOVAL OF THE SIDE
ENTRY DOOR AND ALUMINUM AWNING. NEW RAILING TO BE I	NTEX DARTMOUTH STYLE WITH 4" SQUARE
NEWEL POSTS AND 6" CHAMFERED PORCH POSTS. EXISTING	CONCRETE BLOCK PORCH FOUNDATION
TO BE OBSCURED WITH NEW THIN CUT BRICK, PAINTED 3-D LA	ATTICE PANELS WITH WOOD PANEL FRAMES.
NEW PORCH STEPS AND PORCH DECKING TO BE STAINED TO	NGUE AND GROOVE MAHOGANY MATERIAL.
NEW PORCH SOFFIT TO BE 2" AZEK BEADED BOARD. ALUMINU	JM WINDOWS ADJACENT TO PROPOSED
PORCH WORK TO BE REPLACED WITH NEW SOLID CORE WOO	D 1/1 DOUBLE HUNG WITHIN THE EXISTING
OPENINGS. EAST SIDE DOOR TO RECEIVE A RAISED SILL AND	MATCHING DOUBLE HUNG WINDOW. A NEW
REAR DOOR AND WOOD STEPS AND POWDER COATED BLACK	PORCH LANTERNS ARE TO BE AS PER PLAN.
 Property site visits by Neptune Township Staff, HPC project has been deemed to be complete. The information herein is correct and complete to the The HPC or HPC Application Review Team may repose the considered complete. 	C Members and HPC Professionals until the ne best of your knowledge.
By signing this application, the Owner authorizes the listed Appublic hearing before the Commission.	pplicant to appear as their representative at a
OWNER NAME - Please PRINT	ark Alexander Payliv, AIA PPLICANT NAME - Please PRINT
F/10/22	PLICANT SIGNATURE
5/	10/22

DATE


DATE


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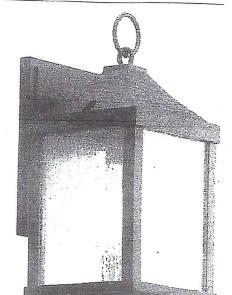


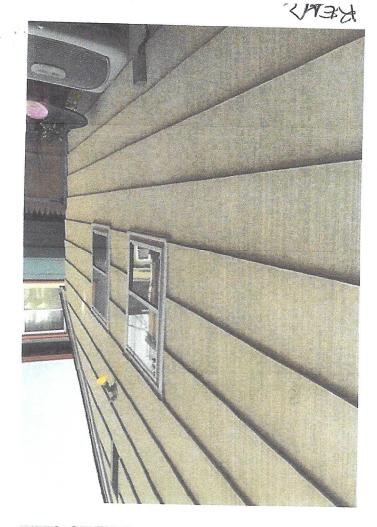


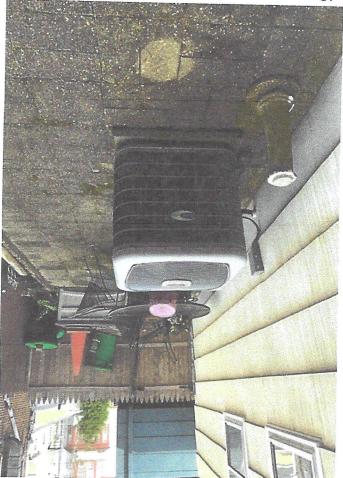BR44 PERS

59HECK AVE

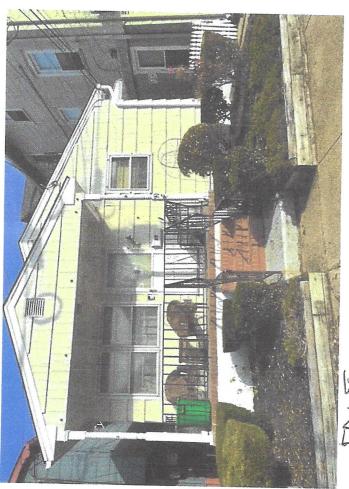400 SEPLES 59 HECK AVE REPLACEMENT WINDOWS Table of Tilt-Wash Double-Hung Window Sizes Scale 1/8" (3) = 1'-0" (305) - 1:96 1'-9 5/8" 2'-1 5/8" Window Dimension 2'-5 5/8" 2'-7 5/8" 2'-9 5/8" 2'-11 5/8" 3'-1 5/8" 3'-5 5/8" 3'-9 5/8" (549) (651) (752)(803) (854) (905) (956) (1057)(1159) Minimum 1-10 1/8" 2'-2 1/8" 2'-6 1/8" 2'-8 1/8' 2'-10 1/8' 3'-0 1/8" Rough Opening 3'-2 1/8" 3'-6 1/8" (562)3'-10 1/8" (664) (765)(816)(867)(917) (968)(1070) (1172)Unobstructed Glass 15" 19" 23" 25" 27" 29" (lower sash only) 31" 35" (381) (483) 39" (584) (635) (686) (737) (787)(889) CUSTOM WIDTHS - 21 5/8" to 45 5/8" (991) to 92 7/8" 3'-0 7/8" (937) 13 15/16" (186) (354)Custom-size windows are 1/8 TW18210 TW20210 available in 1/8" (3) increment TW24210 TW26210 TW28210 TW210210 TW30210 TW34210 TW38210 15 15/16" 3'-4 7/8" See page 84 for custom same HEIGHTS -Grille patterns shown on sega 🚿 TW1832 TW2032 TW2432 TW2632 TW2832 TW21032 TW3032 TW3432 TW3832 CUSTOIN 3'-8 7/8" 17 15/16" (1140)(456) Cottage or reverse cottage sash rate for heights shown below in all widths. CUSTOM WIDTHS - 21 5/8" to 45 TW1836 TW2036 TW2436 TW2636 TW2836 TW21036 TW3036 TW3436 TW3836 CUSTOM HEIGHTS - 48 1/s" to 76 4'-0 7/8" (1241) (1241)19 7/16" (492)TW18310 TW20310 TW24310 TW26310 TW28310 TW210310 TW30310 TW34310 TW38310 Cottage Reverse Cottage 4'-4 7/8" 21 15/16" (1343)(557)TW1842 TW2042 TW2442 TW2642 TW2842 TW21042 TW3042 TW3442 TW3842 4'-8 7/8" (1445)23 7/16" (596) (1445)TW1846 TW2046 TW2446 TW2646 TW2846 TW21046 TW3046° TW3446 TW3846 5'-0 7/8" 25 15/16" (1546)TW18410 TW20410 TW24410 TW26410 TW28410 TW2104109 TW30410° TW34410° TW38410° 5'-47/8" (1648) 27 15/16" (1648)(710)TW1852 TW2052 TW2452 TW2652 TW2852° TW21052 TW30520 TW34520 TW38520 5'-8 7/8" (1749) 29 15/16" (760)TW1856 TW2056 TW2456 TW26560 TW2856° TW21056 TW3056 TW34560 TW38560 Size tables for windows with cottage or 31 15/16" .8/2 0-.9 (1851)(1851) reverse cottage sash are available at andersenwindows.com/sizing. "Window Dimension" always refers to outside frame to frame dimension. TW18510 TW20510 TW24510° TW26510° TW28510° TW210510 TW30510 TW34510° TW38510° "Minimum Rough Opening" dimensions may need to be increased to allow for use 6'-4 7/8" 33 15/16" of building wraps, flashing, sill panning, (1953)(862)brackets, fasteners or other items. See pages 210-211 for more details. Dimensions in parentheses are in millimeters. O Meet or exceed clear opening area of 5.7 sq.ft. or 0.53 m², clear opening width of 20" (508) and clear opening height of 24" (610). See tables on pages 82-83. TW1862 TW28620 TW210620 TW30620 TW3462 TW38629 continued on next page

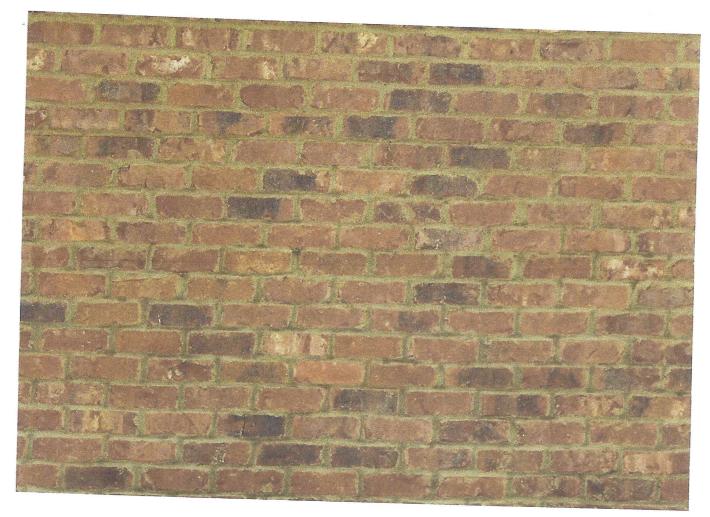

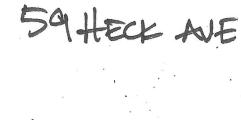







Kichler

Springfield Single Light 13-1/2" Tall Outdoor Wall Sconce

Model: 49984DBK



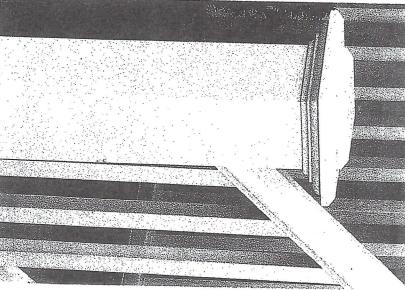

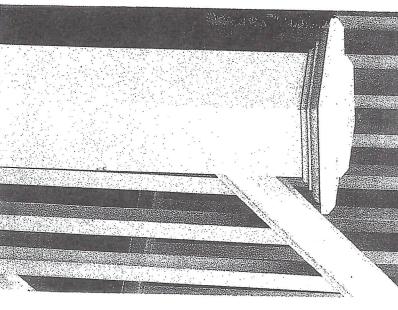


BOTTOM RAIL

TOP RAIL

Porch Railing Details Scale: Schematic/NTS

Railing Newel Post
Scale: Schematic/NTS

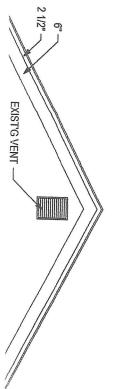

PL

59 HELL AVE

- 4-1/16"

2-3/8"

General Notes

- 1. THE CONTRACTOR SHALL VERIFY ALL DIMENSIONS IN THE FIELD AND INFORM THE ARCHITECT OF ANY CONDITIONS WHICH WOULD PREVENT INSTALLATION OF WORK IN ACCORDANCE WITH THE CONTRACT DOCUMENTS.
- 2. THE CONTRACTOR SHALL AT NO ADDITIONAL COST TO THE OWNER OBTAIN ALL REQUIRED PERMITS AND ARRANGE FOR ALL OF THE INSPECTIONS REQUIRED BY THE LOCAL DEPARTMENT OF BUILDINGS.
- 3. ALL WORK TO BE FILED UNDER AND SHALL CONFORM WITH ALL APPLICABLE CODES AND REQUIREMENTS.
- 4. THE CONTRACTOR SHALL SCHEDULE AND COORDINATE THE WORK OF ALL TRADES AND BE RESPONSIBLE FOR BOTH DAILY AND OVERALL PROJECT SITE CLEAN-UP AT THE CONCLUSION OF WORK.
- 5. SHOULD THERE BE ANY CONFLICT BETWEEN WHAT IS SHOWN ON THE CONSTRUCTION DRAWINGS SPECIFICATIONS, THE CONTRACTOR SHALL BRING SUCH CONFLICT TO THE ATTENTION TO THE ARCHITECT FOR RESOLUTION.
- CONTRACT DOCUMENTS INDICATE TYPE OF DESIGN AND GENERAL CONSTRUCTION AND ARE INTENDED TO IMPLY THE FINEST QUALITY OF CONSTRUCTION MATERIALS AND THE WORKMANSHIP THROUGHOUT.
- 7. THE CONTRACTOR SHALL MAINTAIN ON-SITE A CURRENT AND COMPLETE SET OF CONTRACT DOCUMENTS AS APPROVED BY THE LOCAL BUILDING DEPARTMENT DURING ALL PHASES OF WORK FOR USE BYALL TRADES AND REFERENCE. ALL OUT OF DATE DRAWINGS SHALL BE REMOVED FROM THE JOB SITE.
- UPON ACCEPTANCE OF THE CONTRACT DOCUMENTS, THE CONTRACTOR ASSUMES FULL RESPONSIBILITY FOR THE VARIOUS CONSTRUCTION MATERIALS AND WORKMANSHIP OF THE SCOPE OF WORK DESCRIBED IN THOSE DOCUMENTS AND WILL EXECUTE THE WORK TO COMPLY WITH THE SPIRIT IN WHICH THEY WERE PRODUCED.
- 9. OWNER SHALL ONLY SUPPLY ACCESS TO THE SITE, A SUPPLY OF CLEAN AND POTABLE WATER AND AN 110V AC SOURCE OF ELECTRICITY FOR SMALL HAND HELD POWER TOOLS.

Special Notes

INDEMNIFICATION CLAUSE:

THE OWNER SHALL RELEASE, HOLD HARMLESS AND INDEMNIFY ARCHITECT WITH RESPECT TO ANY CHANGES MADE TO THE CONSTRUCTION DOCUMENTS BY ANYONE OTHER THAN THE ARCHITECT, OR CHANGES IN ANY ASPECT OF THE WORK, OR FAILURE BY THE CONTRACTOR TO BUILD IN ACCORDANCE WITH THESE CONSTRUCTION DOCUMENTS.


PERMITS AND RELATED FEES: CONTRACTOR TO PROCURE ALL REQUIRED CONSTRUCTION PERMITS AS PART OF THE SCOPE OF WORK. OWNER TO PAY ALL

PERMIT AND REQUIRED SURVEY COSTS.

NOTICE OF COPYRIGHT:

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Legend

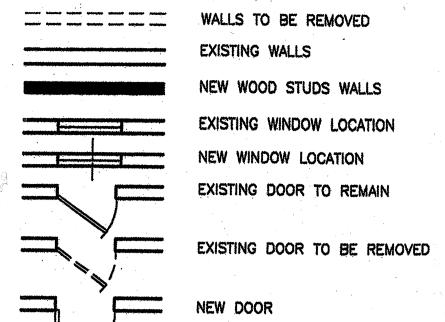

ROOF OVERHANG OR SOFFIT LINE

ELEC. WALL SWITCH ELEC. WALL DIMMER ELEC. 3 WAY SWITCH

ELEC. WALL OUTLET ELEC. FLOOR OUTLET

CEILING MOUNTED LIGHT BRACKET/WALL MOUNTED LIGHT RECESSED CEILING LIGHT

ELEC. HALF-HOT WALL OUTLET

RECESSED DIRECTIONAL LIGHT EXHAUST FAN/HEAT LAMP SMOKE DETECTOR

TV/CABLE JACK

TELEPHONE JACK

DUAL FLOOD/MOTION LIGHT

Area Calculations

Applicant: Michael Harrigan 59 Heck Avenue Ocean Grove, NJ 07756

Site Address: 59 Heck Avenue, Ocean Grove, NJ 07756

Block #209, Lot #13; ZONE: HD-R1

<u>Description</u>: Proposed covered front porch expansion, window and door replacement and related exterior repairs to the existing 1-story 1953 single-family dwelling located at 59 Heck Avenue, Ocean Grove, New Jersey.

LOT SIZE	EXISTING	PROPOSED	RE	QUIRED
Frontage	30.09 ft	no change	>	30.0 ft
Lot Width	30.09 ft	no change	>	30.0 ft
Depth	60.25 ft	no change	>	60.0 ft
Area	1,812.92 sf	no change	>	1,800 sf
SETBACK	EXISTING	PROPOSED	AL	LOWED
Front	9 87 ft	Same	10	O ft

			Andrewson and the second of th	Company of the control of the contro
SI	ETBACK	EXISTING	PROPOSED	<u>ALLOWED</u>
Fr	ont	9.87 ft	Same	10.0 ft
,	edge of dwelling)			
-	ont	4.87 ft	4.66 ft	4.0 ft
Materia	edge of covered po	and the state of t	1 00 C4	A O C4
	ont edge of covered po	4.87 ft	4.00 ft	4.0 ft
Comment of the commen	ast Side	3.82 ft	Same	2.0 ft
	edge of dwelling)	J.02 It	Same	2.0 10
•	ast Side	2.82 ft	Same	2.0 ft
(to	edge of overhang)			
	est Side	2.02 ft	Same	2.0 ft
1.014	edge of dwelling)	1.00 6	and the second s	and the second s
/	est Side	1.02 ft	Same	2.0 ft
1	edge of existing ov ' est Side	ernang)	2.02 ft	2.0 ft \(\)
1	edge of new front	porch overhang)	Lad o W Lad II. U	2.011
Junior		The state of the s		2.1.6
	ear edge of dwelling)	10.66 ft	Same	3.1 ft
	eage of awening)	10.60 ft	Same	3.1 ft
	edge of overhang)	10.00 π	Same	3.1 II
Fl	oor Levels	1 story	Same	2.5 stories
	eight	16.3 ft	Same	35.0 ft
	0		~ ******	

LOT COVERAGE:

	EXISTING	PROPOSED	PERMITTED
Principal Bldg	960.0 sf	960.0 sf Same	
Covered Porcl	h <u>70.0 sf</u>	125.4 sf	•
Building Cove (includes covered po	,	1,085.4 sf (59.9%)	(85.0%)
FrontStep/Wa	lk: 20.0 sf	18.4 sf	N/A
Rear Steps:	none	25.2 sf	N/A
Side Steps:	36.0 sf	none	N/A
Walkways:	142.7 sf	178.7 sf	N/A
AC Units:	4.0 sf	4.0 sf	N/A
Patio Paver:	<u>256.5 sf</u>	231.3 sf	N/A
Total Other:	459.2 sf	457.6 sf	N/A
Total Cover	1,493.2 sf	1,543.0 sf (85.15%)) < (90.0%)

HA	В	IT	AB	LE	FL	O)R	AR	EA	:
										-

	EXISTING	PROPOSED	PERMITTED
First Floor:	960.0 sf	960.0 sf Same	
Total Area:	960.0 sf	960.0 sf Same	N/A

EXISTING 1-STORY DWELLING

LOCATOR MAP

Zoning Districts

B-1: Town Commercial HD-R-1: Historic District Single-Family Residential HD-R-2: Historic District Multi-Family Residential

Zoning Map

Ocean Grove

Township of Neptune

Monmouth County, New Jersey

NEPTUNE TOWNSHIP

HD-B-1

HD-8-1: Historic Mixed-Use
HD-8-1: Historic Mixed-Use
HD-R: Historic District Recreation
HD-0: Historic District Oceanfront
Redevelopment/Rehabilitation Areas

North End Redevelopment Area

Survey provided by Owner:

Survey dated August 18, 1992 was prepared by a licensed Land Surveyor, Roger A. Strevell, PE & PLS and provided by Owner as a site plan reference. Prior to issuance of construction permit, a final site drainage plan and related grading drawings, when so required by local authorities, will be prepared and submitted for final approval,

Site Plan

List of Drawings

- A-1 General Notes, Zoning & Area Calculations & Site Plan
- A-2 Elevations
- A-3 Foundation Floor Plan & Details
- A-4 Specifications Construction Details & Window Schedule
- A-5 Porch Section Details

LOT 845

LOT 844

PIPE FD. 1.05'S , 0.30'W

TWO STORY BRICK BUILDING

S 64° 08' E

LOT

LOT. 843

WOOD FENCE O.6' OVER . .

BLOCK 36

FRAME DWELLING

30.09' N64°08'W

AVENUE

Existing Conditions Survey Reference

30.09

LOT 841

GRIM


LOT 840

30,09

HECK

Scale: 1" = 10'-0

60' RIGHT OF WAY

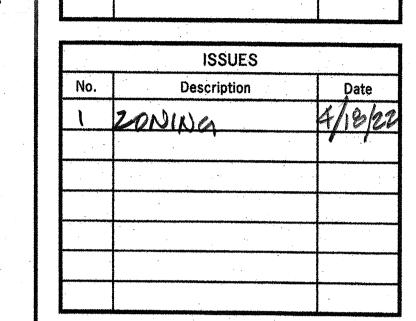

REVISIONS

Date


Description

ZONING

| Mark Alexander Pavliv, AIA

77 Main Avenue, Suite 101 Ocean Grove, NJ 07756

(732) 776 - 8777NJ Lic No. AI00820300 springlakearchitect.com mp77aia@aol.com

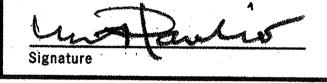

Various Exterior, **Porch and Window** Renovations to the **Existing 1 Story Single-Family Dwelling** Block #209, Lot #13

Use Group: R5 **Construction Type: 5B**


PROJECT NAME Harrigan Residence 59 Heck Avenue Ocean Grove, NJ

DRAWING TITLE General Notes, **Area Calculations** Site Plan


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DATE 1/22	DRAWING No.
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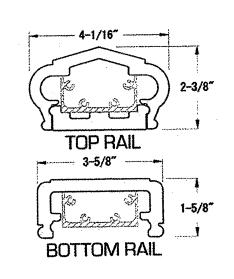


Photo Reference

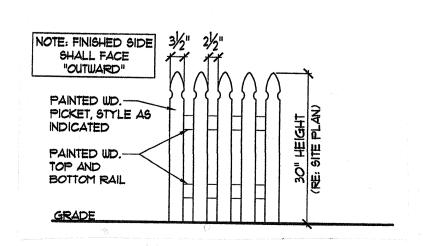


Picket Fence/Gate Detail



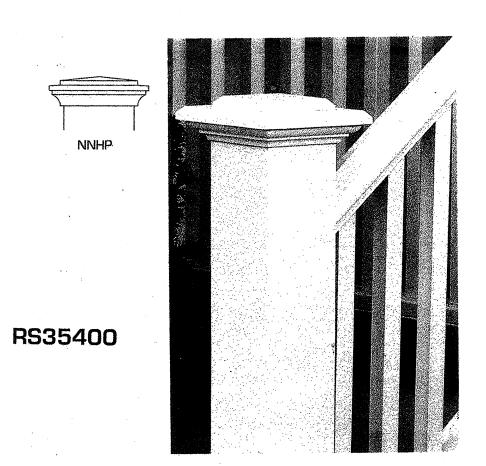


Porch Railing Details Scale: Schematic/NTS

Railing Newel Post Scale: Schematic/NTS

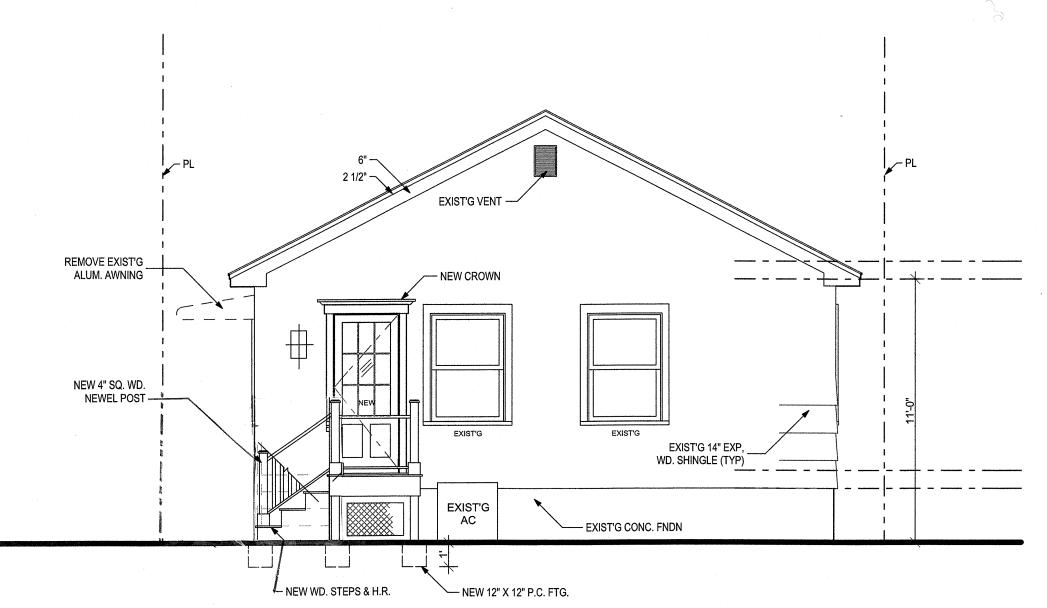



Rear Elevation (North)

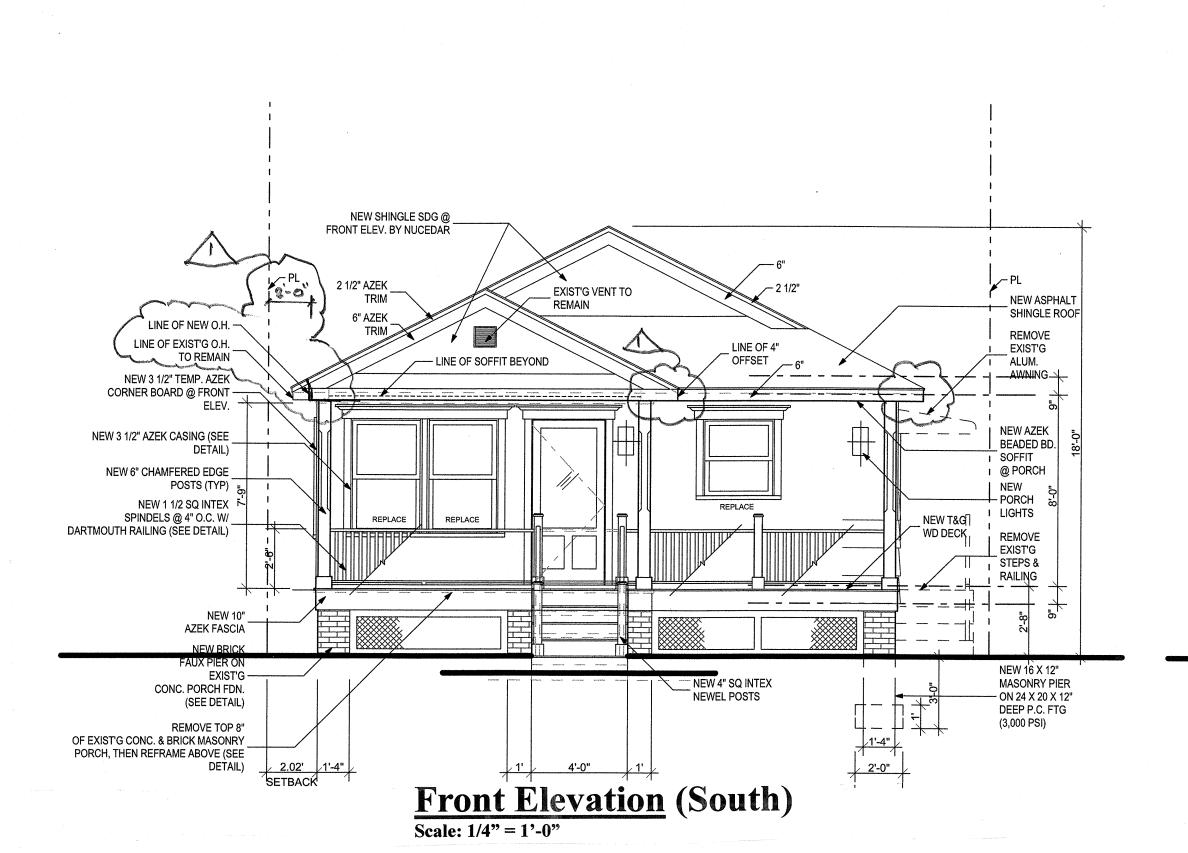


Exterior Light Fixture


Exterior Lighting Compliance Note: All new exterior lighting to comply with Section 402 of the Neptune Township Land Use Ordinance for illumination levels and potential impact onto adjacent properties.

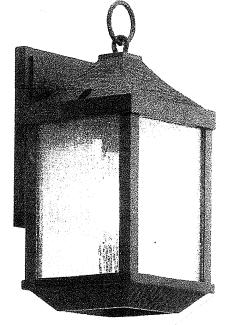

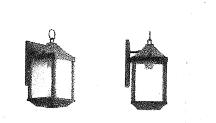

Springfield Single Light 13-1/2" Tall Outdoor Wall Sconce

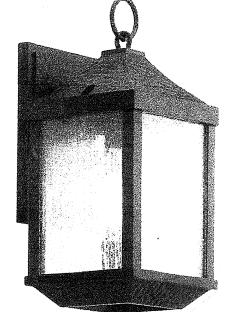

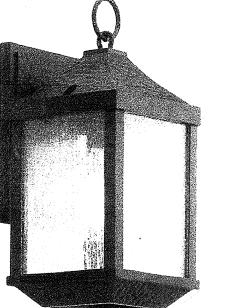

Controlled Roof Drainage to be maintained via a gutter and leader system which must collect and discharge roof water to the ground surface to a minimum distance of 5 feet from the foundation wall onto permeable soil so as to recharge the site.

specified on Typical Section Detail.

All proposed work to comply with the

current International Residential Code

Exterior siding and windows shall be

rated and installed as per manufacturer's

recommendations so as to withstand 120


Contractor to provide all fasteners in


accordance with R802.11 or as otherwise

Special Notes:

New Jersey Edition

mph winds.

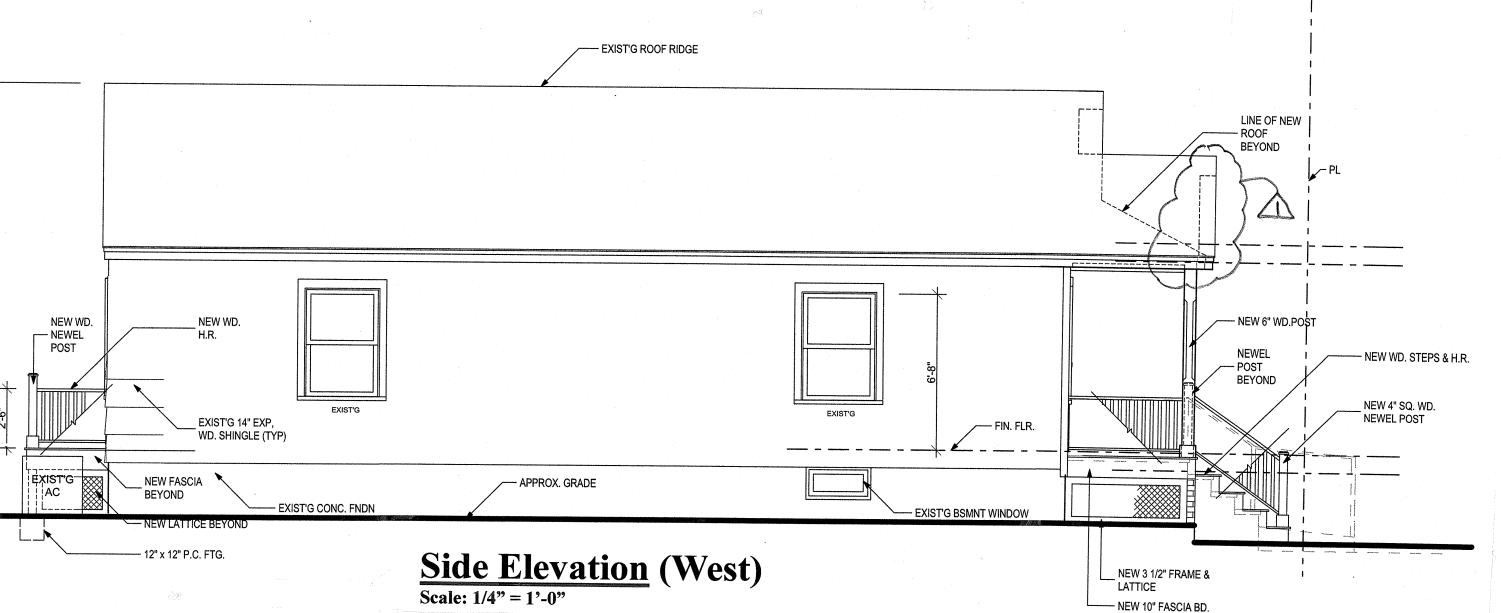

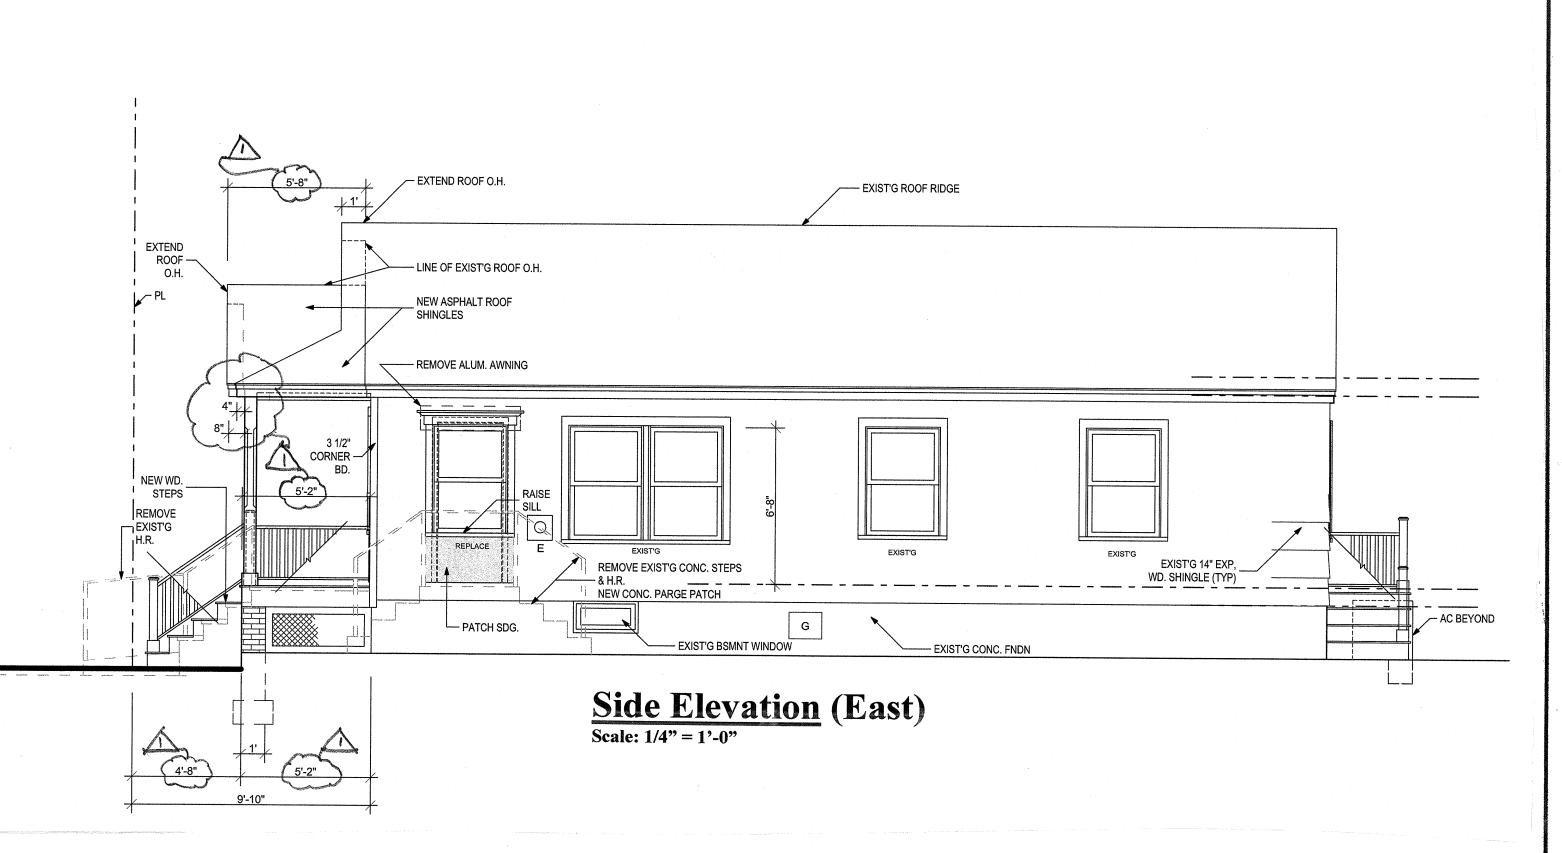


	REVISIONS	
No.	Description	Date
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	ISSUES	
No.	Description	Date,
	ZONING	4/18/22

Mark Alexander Pavliv, AIA

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(732) 776 - 8777NJ Lic No. AI00820300 springlakearchitect.com mp77aia@aol.com



Various Exterior, **Porch and Window** Renovations to the **Existing 1 Story Single-Family Dwelling** Block #209, Lot #13

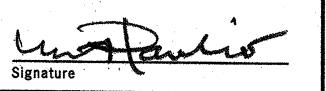Use Group: R5 **Construction Type: 5B**


PROJECT NAME Harrigan Residence 59 Heck Avenue Ocean Grove, NJ

DRAWING TITLE **Elevations**

CHECKED BY

JOB No. 20229959 As Noted DATE 3/1/22 **A2** DRAWN, BY

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PERMITS CONTRACTOR TO PROCURE ALL REQUIRED CONSTRUCTION PERMITS AS PART OF THE SCOPE OF WORK. OWNER TO PAY ALL PERMIT AND REQUIRED SURVEY COSTS.

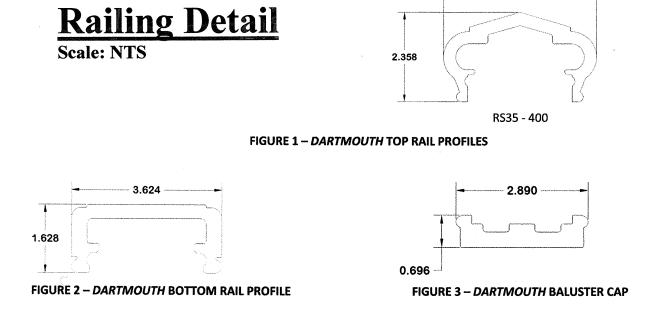Foundation Plan

Scale: 1/4" = 1'-0"

WITH THESE CONSTRUCTION DOCUMENTS.


REVISIONS Description ,Date ZONING

	ISSUES	
No.	Description	Date
	ZONING	4/18/22
		1

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Various Exterior, Porch and Window Renovations to the **Existing 1 Story Single-Family Dwelling** Block #209, Lot #13

Use Group: R5 Construction Type: 5B

PROJECT NAME

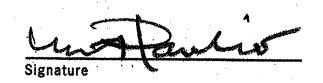Harrigan Residence 59 Heck Avenue Ocean Grove, NJ


Foundation Plan, Floor Plan & Details

SCALE As Noted	JOB No. 202299059
DATE 3/7/22	DRAWING No.
DRAWN BY	A2

EXISTING 1-STORY DWELLING - LINE OF DWELLING BELOW NOTE:
NEW ASPHALT SHINGLE ROOFING EXIST'G — ROOF AS SHOWN SETBACK LINE OF EXIST'G PORCH EXISTING COVERED PORCH PROPOSED PORCH ADDITION LINE OF EXTENDED PORCH DECK

Roof PlanScale: 1/4" = 1'-0"

LINE OF EXISTING _ SOFFIT TO BE EXISTING
REMOVED COVERED PORCH REMOVE EXIST'G LINE OF LOWERED — EXIST'G — PORCH TO REMAIN NEW WOOD NEW 4" WD. NEWEL POST First Floor Plan Scale: 1/4" = 1'-0"

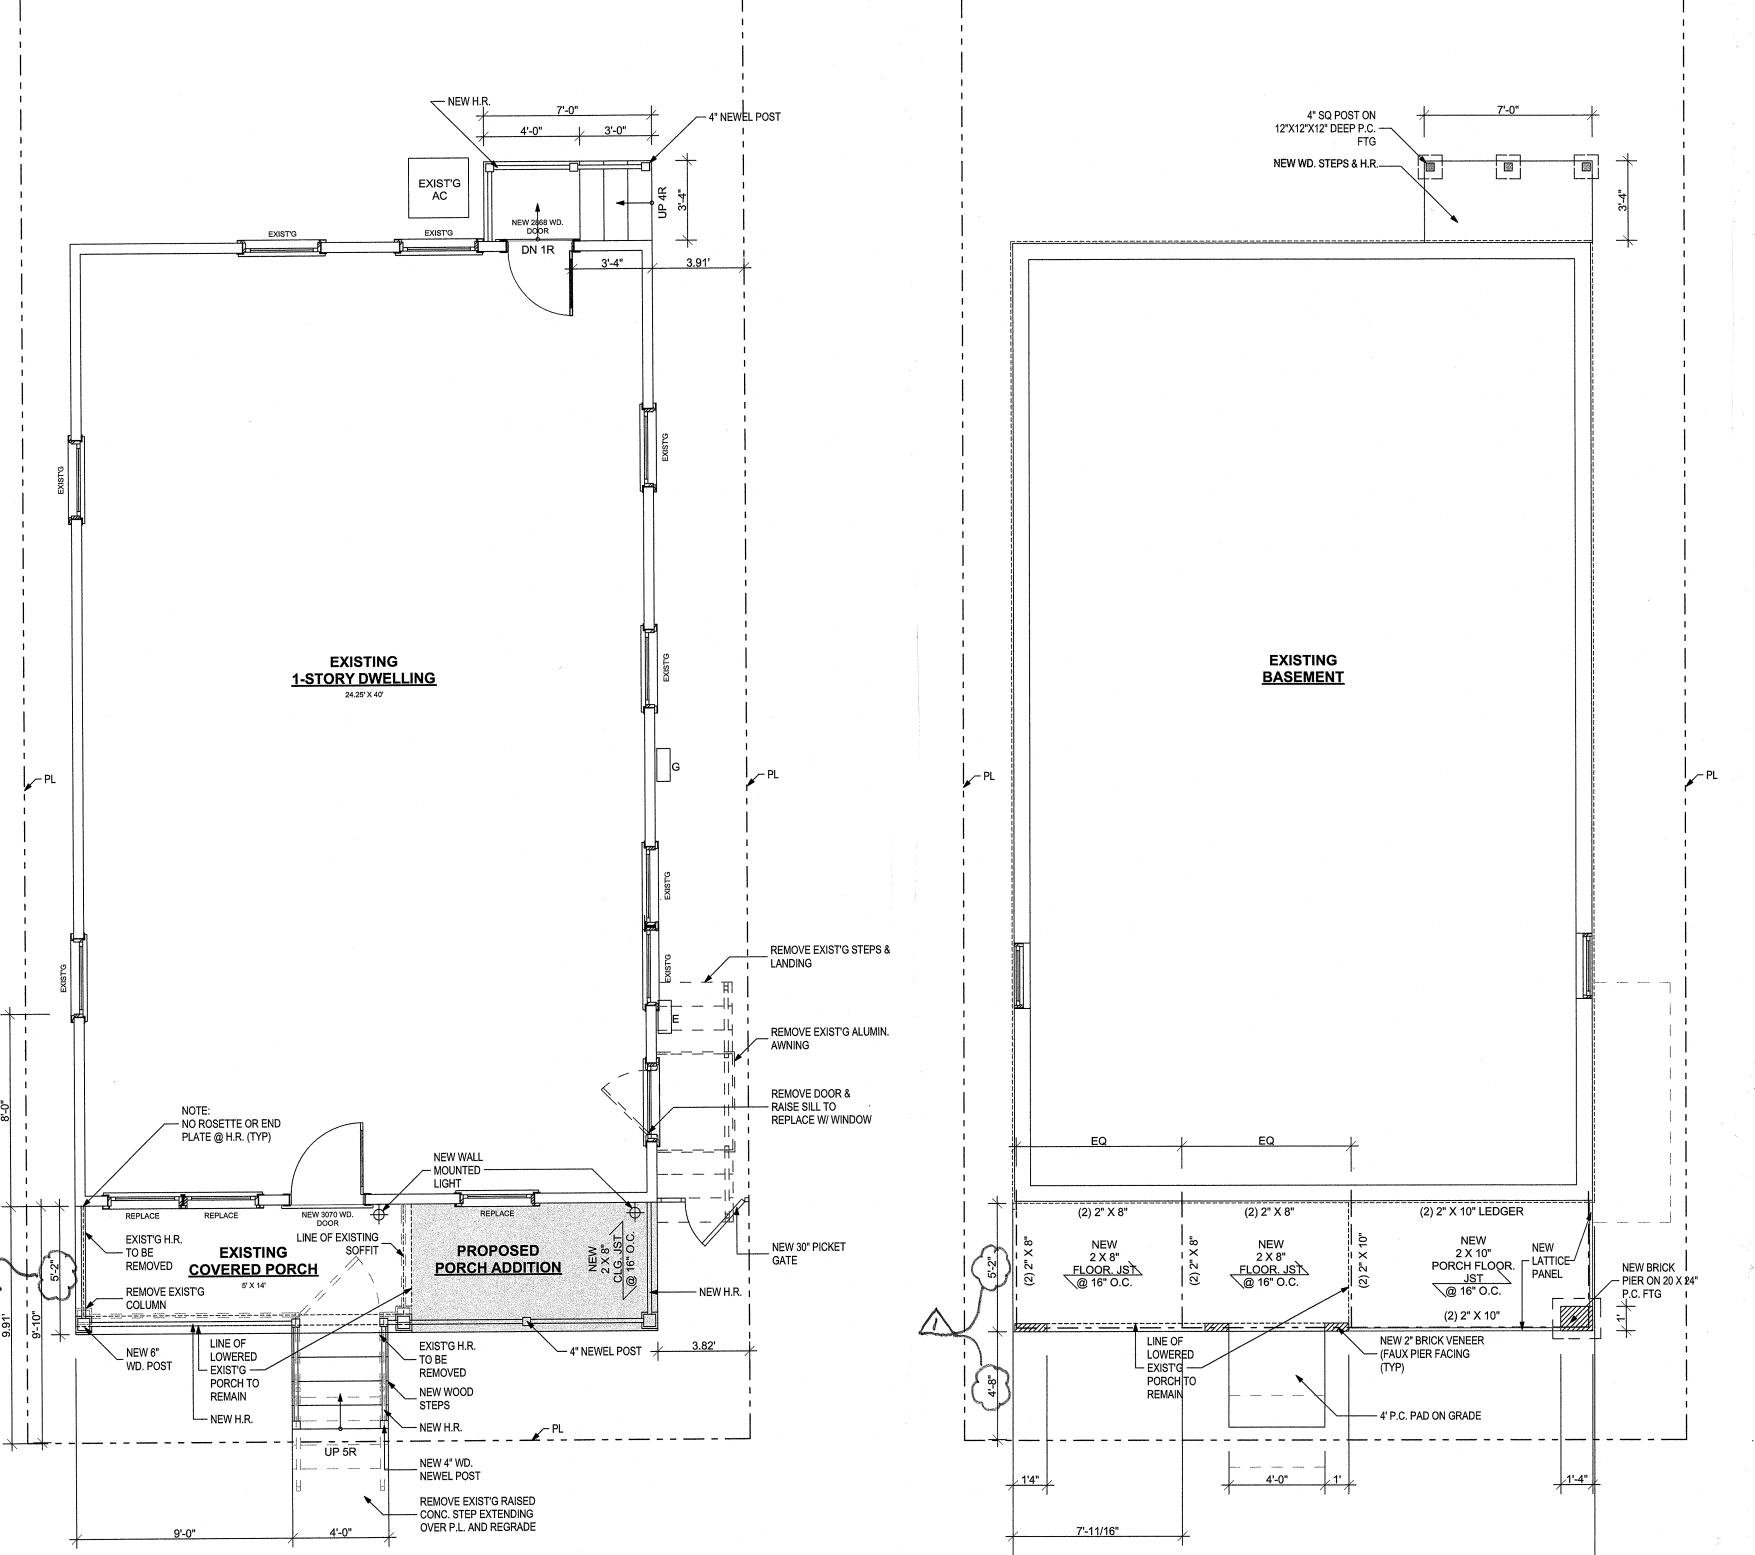

AJ EAC/MP CHECKED BY

Specifications:

Division 1 - General Conditions All work to comply with the Current International Residential Code/New Jersey Edition.

Upon acceptance of the Contract Documents and Agreement with the Owner, the General Contractor assumes full responsibility for the construction, materials, methods and workmanship necessary to complete the scope of the project as described in those documents and will execute the work in the conceptual spirit and design intent in which the documents have been produced.

All construction permits are to be procured by General Contractor and paid by Owner.

The Contractor is responsible for becoming familiar with all existing site conditions and circumstances prior to the signing of the Agreement.

The Contractor is to comply with all General Notes and Requirements listed in the construction documents. Specifications have been provided to assist the Contractor in the implementation of the project.

Contractor to be responsible for the storage and protection of all items immediately upon and after delivery to the project site until issuance of the final Certificate of Occupancy.

Lead Paint, Asbestos or other Hazardous Material:

Contractor responsible for the identification and removal of any of the above noted environmentally sensitive materials in a manner that is safe and in compliance with all health and safety requirements, in the event such materials are found during the course of demolition, or construction, at no additional cost to the Owner.

Demolition and Removals:

All existing siding, window, door and corner trim within the proposed area of work graphically indicated on plans or otherwise required to be removed to complete the proposed renovations, are to be removed.

Existing masonry front porch is to remain but top concrete slab and brick edge is to be removed to accommodate new ACQ framing, as detailed, to allow for new 1" T&G wood decking as specified and approved by HPC.

Existing front porch brick masonry steps and raised concrete walk at base of steps are to be removed to allow replacement with new wood steps and railing, as specified.

East alley concrete steps and landing are to be removed together with the existing aluminum fixed awning, as per

Contractor is responsible for the provision and associated costs of all required demolition, dumpsters, removals and disposal of debris in accordance with local regulations.

Division 2 - Site Work

Site Work: Contractor to restore any and all disturbed grade conditions immediately adjacent to work areas in an orderly and workmanlike manner as may be required at the completion of the project.

Controlled Roof Drainage to be maintained via a gutter and leader system which must collect and discharge roof water to the ground surface to a minimum distance of 5 feet from the foundation wall onto permeable soil so as to recharge the site in accordance with R801.3.

Division 3 - Concrete

Footings & Foundations:

New concrete footings designed for soil bearing capacity of 2,500 lbs/sf min. All footings to sound bearing to 3'-0" below grade as per plan and are to be 12" deep with a minimum 4" footing projection and be of an ultimate strength of not less than 3,500 psi in 28 days.

Division 4 - Masonry

Brick Masonry Piers:

Contractor to construct new brick piers in accordance with details provided and set upon new 12" deep poured concrete footings to sound bearing to 3'-0" below grade.

Division 5 - Metals

Fasteners & Hangers:

All metal hangers and other ties and connectors to be as manufactured by "Simpson" or equal or as otherwise approved by the Architect.

All metal hangers and other ties in contact with pressure treated ACQ lumber shall be zinc coated and compliant with ASTM A-153 so as to be compatible with ACQ as required.

Division 6 - Woods & Plastics

Any new framing lumber at area of replacement windows at rear elevation to be Douglas Fir, Standard Grade and better with a minimum fiber stress of 1250 psi. Any replacement sill plates, if required, in areas where framing is in direct contact with concrete or masonry foundation walls shall be ACQ Pressure Treated.

Any new or required replacement window and door headers to be a minimum of two (2) 2"x10" or as approved by the Architect due to limiting field conditions.

When required, any new exterior wall sheathing to be 1/2" minimum CDX plywood nailed to Code. Sheathing on any exterior walls within 5'-0" of property line to be 1-hour fire rated exterior grade gypsum board. Any new wall sheathing to be nailed to Code at 6" o.c.

All new wood porch joists in areas where proposed work, or other conditions are exposed, are to be framed with similar joist dimension and spaced at 16" o.c. Joist end conditions at all new 2 x 10" wood porch deck floor joists to be securely fastened at each end utilizing Simpson hangers HUS210 or equal. All new porch ceiling rafters and joist to be 2 x 8" as detailed in the section detail provided.

Exterior Architectural Trim:

All new ornamental architectural trim, window drip and door caps and all new door and window surrounds, as shown on the Elevations and Details, are to be synthetic polymer as manufactured by Azek or approved equal and painted as approved by the HPC Resolution.

New window and door surrounds to be 5/4" thickness in order to attain proper dimensional relief. All staple holes and fastening dibits to be filled and sanded in preparation of application of paint.

New Porch Access and First Floor Entry Stairs:

All such stairs, where indicated on plan, are to be closed box stair type and constructed utilizing matching stained T&G mahogany treads and painted Azek risers and closed stringers.

New Porch Floor Planking:

New exterior wood stair treads and wood deck surface to be 3 ¼ x 1" hardwood planking. All porch decks to pitch to drain at 1/8" per foot minimum.

Division 7 - Thermal & Moisture Protection Application of caulk at any new or modified window and door perimeters as well as other through wall penetrations and joints are subject to approval by the Architect on-site.

Exterior Siding and Other Facings:

Exterior siding, or other facings, shall be rated and installed as per manufacturer's recommendations so as to withstand a minimum of 120 mph winds in this zone.

All exterior finishes, materials and facings are to be as shown on the Elevation Drawings and to the limits of the front elevation terminating with corner boards.

Contractor to provide and install new simulated shingle siding as manufactured by NuCedar siding with 7" exposure, in areas noted on elevations. Color to be white to match all existing wood cedar siding to remain. Any deviation in siding color is subject to approval by Architect and HPC. All exterior fasteners shall be stainless steel.

Roofing:

New self sealing fiberglass composite asphalt shingle roofing to be "GAF Timberline" and wind rated to 120mph. All new roofing shingles shall conform to ASTM 3462 with a minimum of 8 fasteners per shingle. Contractor to install ice and water shield where existing structure adjoins areas or proposed work. New roofing at proposed porch roof area shall be rated and installed as per manufacturer's recommendations.

Vapor Barrier Paper and Wraps:

New exterior wall sheathing at front elevation to receive Dupont Tyvek Housewrap, or equal, in accordance with manufacturer recommended installation methods.

Contractor to install ice and water shield over all roof conditions with a limited slope of less than 4 over 12.

Division 8 - Doors & Windows

Replacement windows and doors shall be rated and installed as per manufacturer's recommendations so as to withstand a minimum of 120 mph winds in this zone.

Any new windows to be solid core wood units, where indicated, and be Low-E4 insulated clear glass with screens, as manufactured by Andersen Windows and Doors, 400 Series in standard White color as approved by HPC.

Sizes for windows to be verified in the field or as otherwise identified on plans. Interior sash and frame to be factory finished in white.

Contractor is responsible to verify provided window designations, egress compliance and sizes in field and notify Architect of any conflicts. Interior window hardware to factory finished white.

All glazed window or door panels greater than 9 square feet in area or greater than 36 inch in edge to edge dimension or within 1 foot distance from adjacent doors or within the swing distance of a hinged door must be tempered.

Provide and install new pre-hung SIMPSON 3068 solid core wood door with tempered clear glass upper panel and dual lower recessed panels with saddle and all weather stripping.

Provide and install new pre-hung THERMA-TRU insulated solid core Smart Star #S262 2868 in-swing exterior door with saddle and all weather stripping.

Division 9 - Finishes

Gypsum Board:

Any required interior patching related to door and window replacement is to be ½" Gypsum Board to be screwed and glued and be ½" minimum or in accordance with fire rating requirements for exterior walls within 5 feet of side and rear property lines.

Exterior Railing Systems:

New front step hand railings to be new painted INTEX "Dartmouth Style" with a 1 ½" square spindle to match existing porch railings and spaced at a maximum of 4" o.c. to comply with Code and to replicate existing spindle pattern and spacing.

All new first floor top of rail height to be 30" with a 36" railing height at new and replaced porch access stairs to comply with Code.

Provide graspable 2 1/4" wood hand at front access steps. Provide new Newel Posts with a 4" square smooth faced configuration and 2-tiered newel post cap, as per proposed plan and elevations.

Interior Trim:

Any required replacement interior window casing to be new painted clear grade primed pine wood and finished to match all existing interior trim.

Any and all field conflicts and special conditions are to be brought to the attention of Architect. Trim with wood knots will not be acceptable.

Interior Paint:

All interior walls where touch-up is required due to window replacement is to receive a minimum of two coats of Benjamin Moore latex flat paint, or as otherwise requested by Owner.

All interior window casings and trim to be primed and receive two coats of Benjamin Moore satin enamel paint. or as otherwise requested by Owner.

Exterior Paint:

The front porch columns are to be square 6" painted Azek clad type over 4" square pressure treated ACQ Structural Wood Posts. Posts to receive base and cap detail as indicated on elevations and have chamfered post edges as detailed and approved by HPC.

The areas not to be covered with facing material are to be painted with two coats of Benjamin Moore Latex or equal.

Division 10 - Specialties Not included.

Division 11 - Equipment Not included.

Division 12 - Furnishings Not included.

Division 13 - Special Construction Not included.

Division 14 - Conveying Systems Not included.

Division 15 - Mechanical/Plumbing

Division 16 - Electrical

All electrical work is to be connected to service panels by Contractor. All electrical work to be installed as per the provided electrical schematic plan and fixture locations and type specified.

Electrical Service:

Contractor to coordinate all aspects of application, permit procurement and associated with electrical wiring alterations and additions.

Electrical Wiring and Requirements:

Contractor to install all new circuits and services as schematically indicated on the drawings.

All new wires to be concealed, constructed of copper with thermoplastic insulation and sized in accordance with Code.

All switches, outlets and other devices shall be appropriate for their intended use with UL Certification.

Unless otherwise noted, all switches shall be mounted at standard 4'-2" height above finished floor. GFI's to be provided as required and where indicated on plans.

Lighting Fixtures:

All surface mounted fixtures to be supplied by the Owner and installed by the Electrical Sub-contractor.

Exterior Lighting Compliance Note:

All new exterior lighting to comply with Section 402 of the Neptune Township Land Use Ordinance for illumination levels and potential impact onto adjacent properties.

Window and Exterior Door Schedule

Room or Area	Quantity	Manufacturer #	Glazing	Egress	Full Divided Lite	Type/Comments
FRONT ELEVATION	<i>T</i>					
Living Room	1	Simpson Wood 3068	Tempered Upper	N/A	See Elevation	In-swing Door Sout
Living Room	2	TW210410	Low E4	N/A	1 over 1 lite	Double Hung South
Kitchen	1	TW2832 V.I.F`	Low E4	N/A	1 over 1 lite	Double Hung South
EAST ELEVATION				And the second s		
Kitchen	1	TW210410 (V.I.F.)	Low E4	N/A	1 over 1 lite	Double Hung East
WEST ELEVATION						
Living Room	1	TW210410	Low E4	N/A	1 over 1 lite	Double Hung West
REAR ELEVATION					Clin Calaria 1/2 Pe	
Bedroom	1 (Th	erma-tru 2868 #S262	Low E4	Yes	7	anel - Smooth Star Do I In-swing Door No.

Window sizes as per Schedule to be verified in field by Contractor. Screens are to be provided. Window Designations are referencing Andersen Windows and Doors – 400 Series unless otherwise noted above or approved by the Architect.

Replacement windows to be factory clad exterior with factory finished interior wood core primed and painted pine. Exterior window frame and sash color to be Standard White, or as otherwise approved by HPC. Final order subject to field measurement and verification by Contractor and approval of vendor prepared detailed Shop Drawings with Specification to be approved by Architect in writing. Contractor is responsible to verify all window designations and sizes in field and notify Architect of any conflicts.

Any upgrades and/or deviations from the above are to be submitted to Owner and Architect for review approval.


Windows to be solid core wood with full divided lites with spacer bars and be manufactured with High-Performance Insulated Low-E4 Glazing, and have a factory painted interior finish as manufactured by Andersen Windows and Doors. Provide window sash configuration as per elevations and provided Window Schedule as approved by HPC and Architect.

Interior window hardware to be standard factory white unless otherwise requested and approved by Owner.

All glass to be tempered where bottom edge of glass is less than 5 feet from the floor at tub and shower areas, within a 24" arc of all hinged doors; or within 36" of any walking path and not separated by a railing with at least an 18" space between the railing and glazed surface

Front entry door to be pre-hung solid core 1 3/4" wood with weather stripping and aluminum saddle as manufactured by Simpson Wood Doors, or owner approved Equal.

Rear access door to be smooth faced with upper glass panel and dual recessed lower half panel as manufactured by Therma-tru Doors.

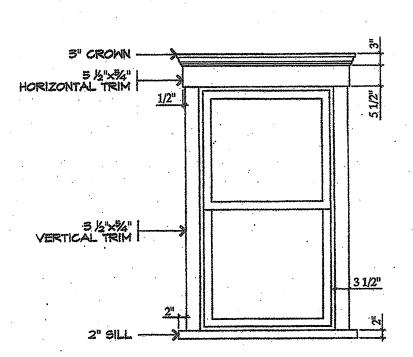


Typical Window Trim Detail

Exterior Siding Nails:

Scale: 1/2" = 1'-0"

Contractor to utilize stainless nails in all shingle and trim applications.

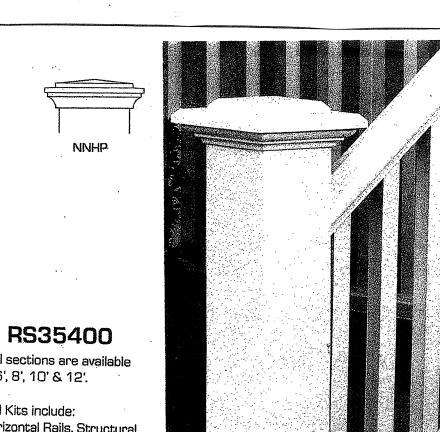

Railing Newel Post

Scale: Schematic/NTS

Rail sections are available in 6', 8', 10' & 12'.

Rail Kits include: Horizontal Rails, Structural Reinforcements, Square Balusters, Hardware and Crush Blocks

Rail Sets include: Horizontal Rails, Structural Reinforcements, Brackets, Screws and Crush Blocks

4-1/16" TOP RAIL 3-5/8"

BOTTOM RAIL

Porch Railing Details Scale: Schematic/NTS

ISSUES Description Date ZONING

REVISIONS

Date

4/18/22


Description

ZONING

Mark Alexander Pavliv, AIA

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Various Exterior, **Porch and Window** Renovations to the **Existing 1 Story Single-Family Dwelling**

Use Group: R5 **Construction Type: 5B**

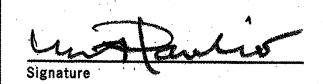Block #209, Lot #13

PROJECT NAME

Harrigan Residence 59 Heck Avenue Ocean Grove, NJ

DRAWING TITLE **Specifications**

CHECKED BY

Typical Details & Window Schedule

SCALE 2022-49059 As Noted 3/1/22 DRAWING No. DRAWN BY OP/MP/EAR


Special Notes:

- 1. Various covered porch framing connections to utilize Simpson Strong Ties fastening devices in accordance with manufacturer's specifications.
- 2. Covered porch joists framing end conditions to utilize Simpson HUS210 Strong Ties at each end.
- 3. New posts are to be secured at top and bottom with Simpson Strong Tie Strap H-8 or equal and be secured as applicable. Each strap to be covered with base or top cap as required in order to obscure fastening device.
- 4. All New First Floor porch deck framing to be secured to existing dwelling with a minimum 2" x 10" pressure treated wood ledger which is fastened to the structure with ½" zinc coated compatible lag bolts staggered at 24" on center and no closer than 2" to top and bottom edge of new wood ledger.
- 5. Exterior wood steps to be a minimum 11" full tread dimension and maximum 7" riser ht.
- 6. Railing height at First Floor covered porch to be as shown on the elevations.
- Railing height at Steps to be uniform and measure from the tread nosing at a minimum of 34" and maximum of 38" and have a graspable railing with an outside diameter dimension of at least 1 1/4" but not more than 2", and replicate appropriate historic railing profile.

5/2"

Porch Column Detail

Scale: Schematic/Not to Scale

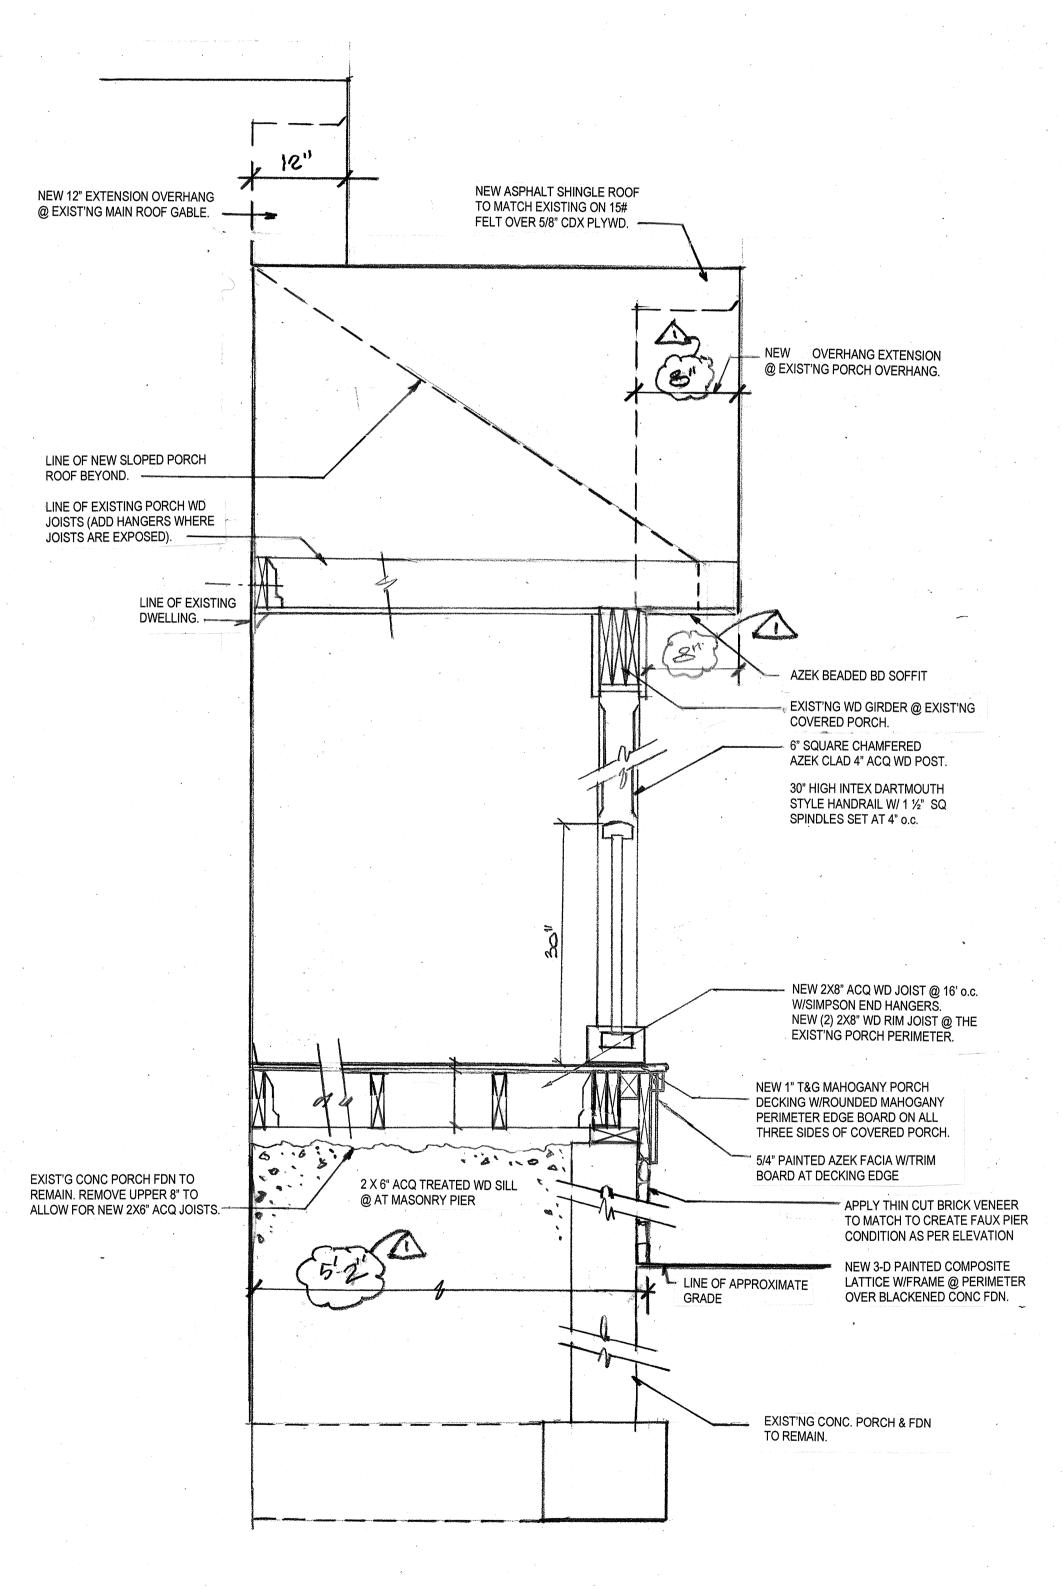




Design loads in accordance with **Current IRC/NJ Edition to be:**

Snow and Roof Load: Attic Live Load: First Floor Live Load: 45 pounds per sq. ft. Second Floor Live Load: 35 pounds per sq. ft. Design Wind Load:

20 pounds per sq. ft. 20 pounds per sq. ft. 120 miles per hour

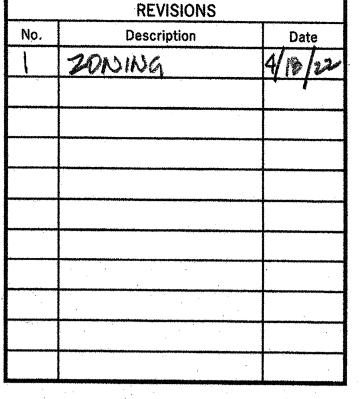


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Various Exterior, **Porch and Window** Renovations to the **Existing 1 Story** Single-Family Dwelling

Use Group: R5 Construction Type: 5B


Block #209, Lot #13

PROJECT NAME Harrigan Residence 59 Heck Avenue Ocean Grove, NJ

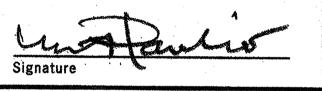
DRAWING TITLE **Front Porch Section Details**


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SCALE As Noted 20229059 DRAWING No. 2/1/22 **A5** DRAWN, BY MP/EACLEM

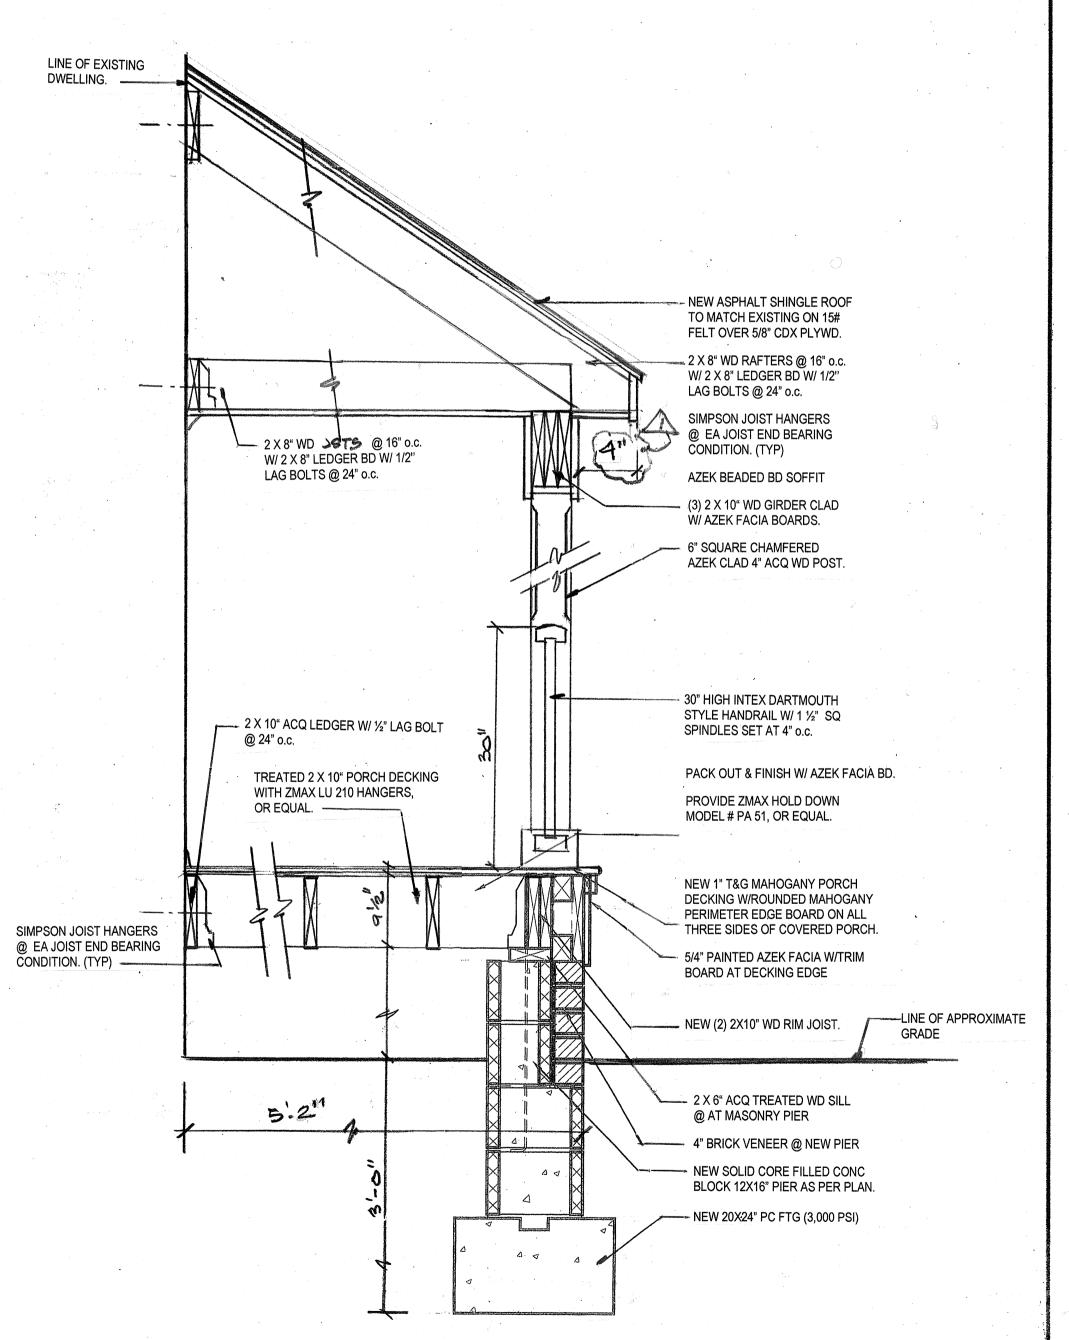


Porch Section Detail at Addition



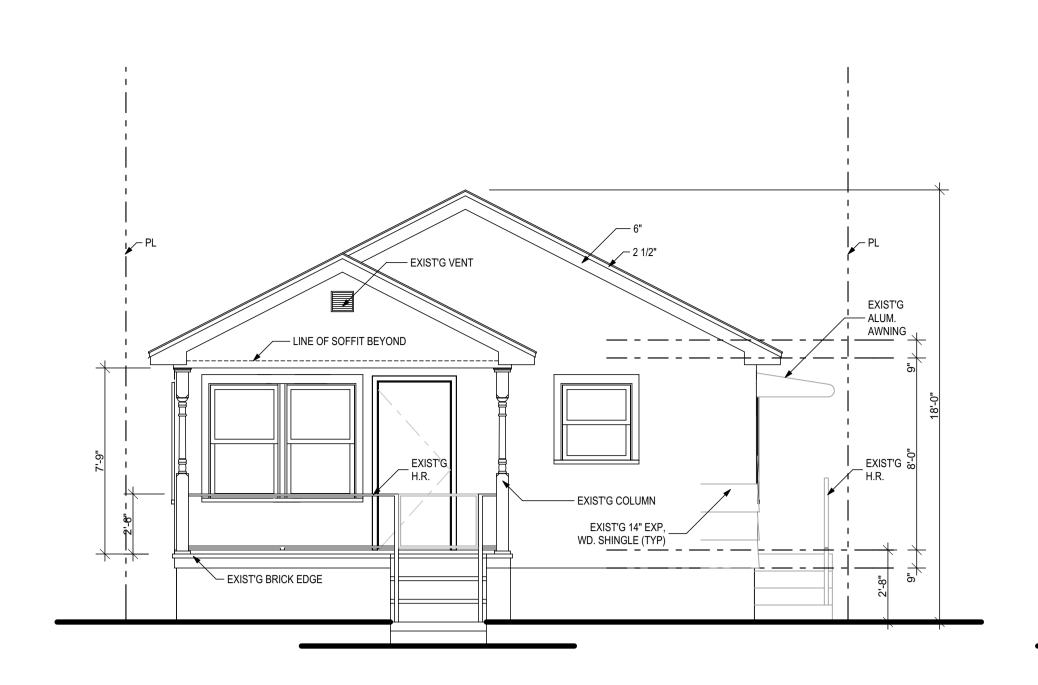

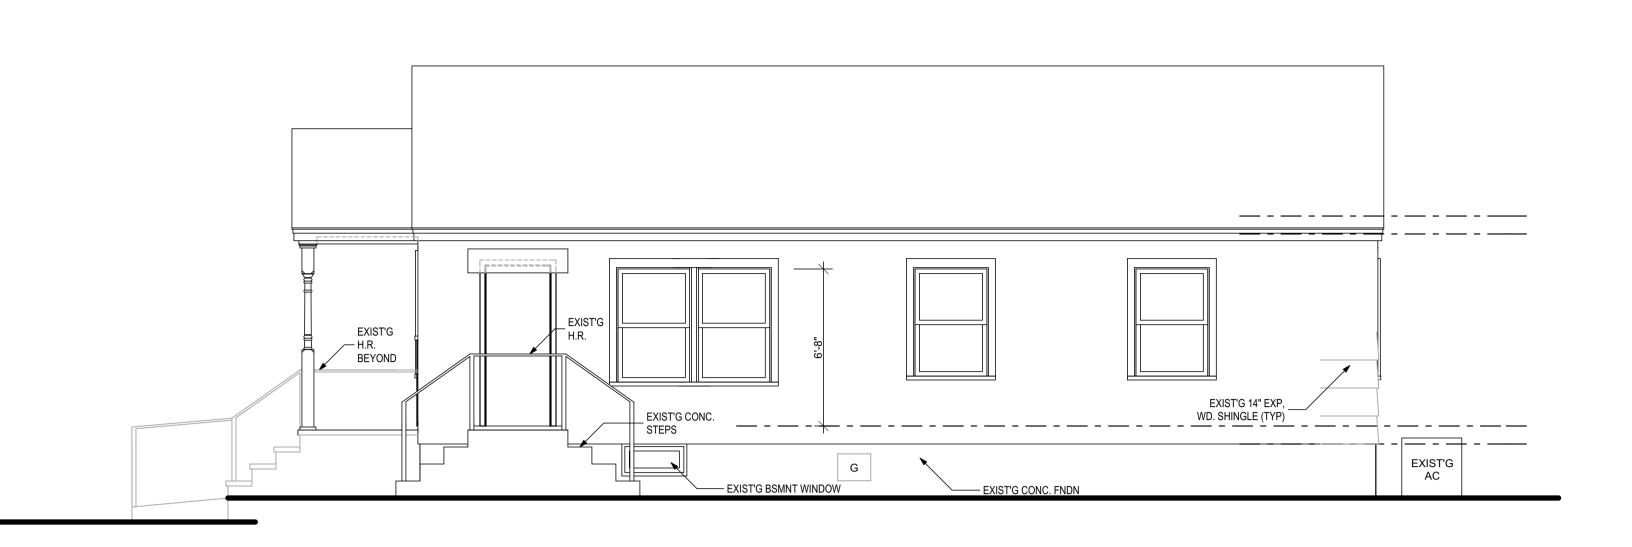SOUTH ELEVATION 1/4" = 1'-0" EAST ELEVATION

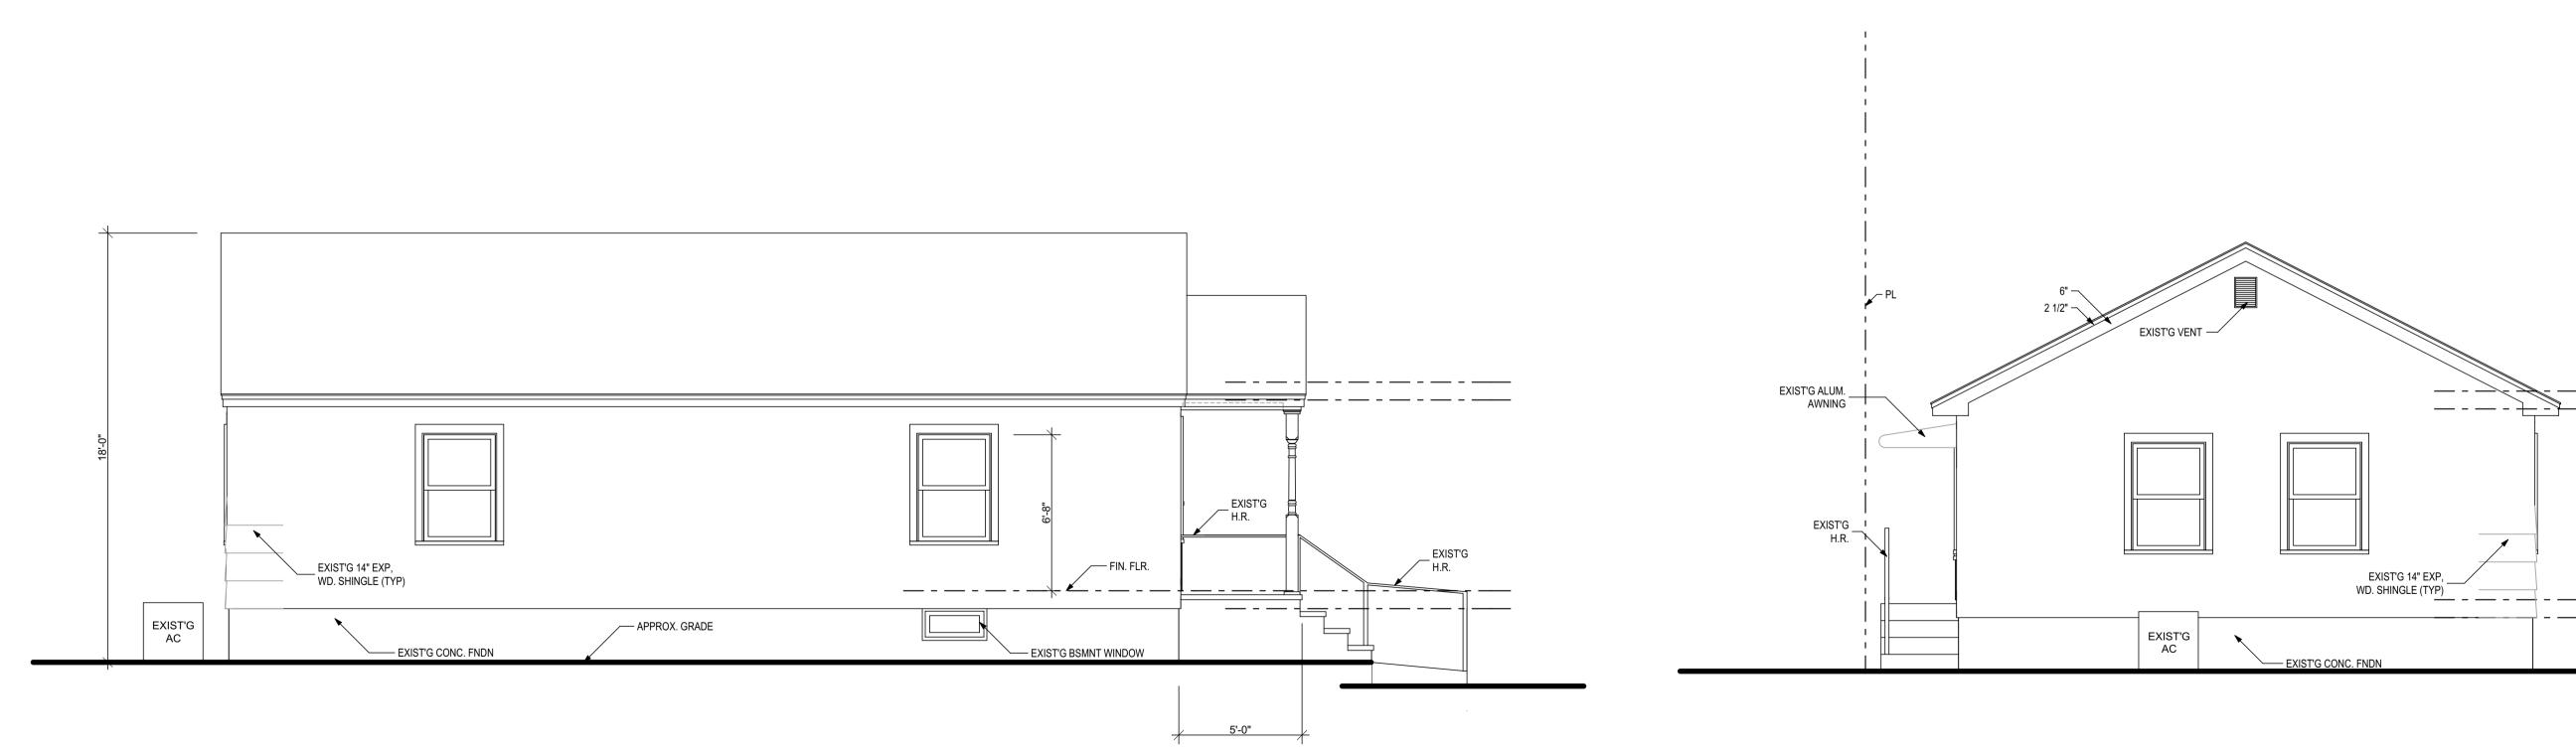

1/4" = 1'-0"

1/4" = 1'-0"