HARBOR FREIGHT MINOR SITE PLAN

BLOCK 1004, LOT 5, PLATE 10 NEPTUNE TOWNSHIP MONMOUTH COUNTY, NEW JERSEY

LIST OF PROPERTY OWNERS WITHIN 200'

MUN	BLOCK	LOT	QUAL	Location	Owner Name	Owner Street	Owner Csz	Zoning	Tax Map Sheet
Neptune Twp	506	15		108 Drummond Ave	DENTE, EUGENE	P.O. BOX 906	NEPTUNE, NJ 07754	C-7	5
Neptune Twp	507	4		26-28 Highway 35	JAAD MANAGEMENT, LLC	11 THORN LANE	CHESTERFIELD, NJ 08515	C-7	5
Neptune Twp	508	1		20 Highway 35	CROSSROADS OF JERSEY SHORE, LLC	37 ROUTE 35	NEPTUNE, NJ 07753	C-7	5
Neptune Twp	508	2		24 Highway 35	LM KIDS, LLC	37 LUDLOW AVENUE	SPRING LAKE, NJ 07762	C-7	5
Neptune Twp	514	1.01		1704 Huntington Ave	MY PROPERTY HOLDINGS GROUP LLC	601 OAKMONT LANE STE 400	WESTMONT, IL 60559	C-7	5
Neptune Twp	514	5		8 Highway 35	ALCOVE INVESTMENT, INC & SIMONE REV	4415 HIGHWAY 6	SUGARLAND, TX 77478	C-7	5
Neptune Twp	1004	2		57 Highway 35	BILL JIM, INC % CONNIE DELNERO	12275 SW BAYBERRY AVENUE	PORT ST LUCIE, FL 34987	C-7	10
Neptune Twp	1004	3		55 Highway 35	THIRD GARDEN PARK	29 KNAPP ST, PO BOX 4401	STAMFORD, CT 06907	C-7	10
Neptune Twp	1004	4		37 Highway 35	37 RT 35, LLC	37 HIGHWAY 35	NEPTUNE, NJ 07753	C-7	10
Neptune Twp	1004	5		15 Highway 35	15 ROUTE 35 NEPTUNE INVESTORS, ETAL	52 MILLBURN AVENUE	SPRINGFIELD, NJ 07081	C-7	10
Neptune Twp	1004	6		9 Highway 35	MCDONALD'S REAL ESTATE COMPANY	HWY 33 & 35	NEPTUNE, NJ 07753	C-7	10
Neptune Twp	1004	7		1 Highway 35	AMOCO OIL CO.% LEVIN MGT CORP.	PO BOX 326	PLAINFIELD, NJ 08061	C-7	10
Neptune Twp	1004	8		1417-1421 Corlies Ave	ANNY'S LLC	1417 CORLIES AVENUE	NEPTUNE, NJ 07753	C-7	10
Neptune Twp	1004	9		1423 Corlies Ave	B.N.F. NJ	1423 CORLIES AVENUE	NEPTUNE, NJ 07753	C-7	10
Neptune Twp	1106	1		1414 Corlies Ave	CASTRO, TYLER	1414 CORLIES AVE	NEPTUNE, NJ 07753	C-7	11
Neptune Twp	1106	2		1412 Corlies Ave	VELARDI, THOMAS & CHRISTINE	2 HOOPER COURT	MILLSTONE, NJ 08510	C-7	11
Neptune Twp	1106	3		1410 Corlies Ave	GATEWAY NEPTUNE, LLC	247 BRIDGE AVE STE 5	RED BANK, NJ 07701	C-7	11
Neptune Twp	1106	4		1408 Corlies Ave 1/2	GATEWAY NEPTUNE, LLC	247 BRIDGE AVE STE 5	RED BANK, NJ 07701	C-7	11
Neptune Twp	1106	5		1408 Corlies Ave	GATEWAY NEPTUNE, LLC	247 BRIDGE AVE STE 5	RED BANK, NJ 07701	C-7	11
Neptune Twp	1107	1		1422 Corlies Ave	ANDREWS, CHRISTOPHER & SUSAN KNOUD	1422 CORLIES AVENUE	NEPTUNE, NJ 07753	C-7	11
Neptune Twp	1107	2		1418 Corlies Ave	BREVAL, MOSE	1418 CORLIES AVE	NEPTUNE, NJ 07753	C-7	11
Neptune Twp	1107	3		1416 Corlies Ave	OEN, EVELYN CASTILLO	12375 UPPER PRESTON RD SE	ISSAQUAH, WA 98027	C-7	11
Neptune Twp	1107	11		2 Union Ave 1/2	UNIONNJ, LLC	2 UNION AVENUE 1/2	NEPTUNE, NJ 07753	C-7	11
Neptune Twp	1107	12		2 Union Ave	BARON, JENNIFER A	310 LAKEWOOD ROAD	NEPTUNE, NJ 07753	C-7	11

APPROVED BY THE MUNICIPAL BOARD ON THIS __DAY OF ____20

I HEREBY CERTIFY THAT I AM THE OWNER OF RECORD OF THE SITE

HEREIN DEPICTED AND THAT I CONCUR WITH THE PLAN


APPLICATION#


CHAIRPERSON


BOARD ENGINEER

OWNER

ADMINISTRATIVE OFFICER

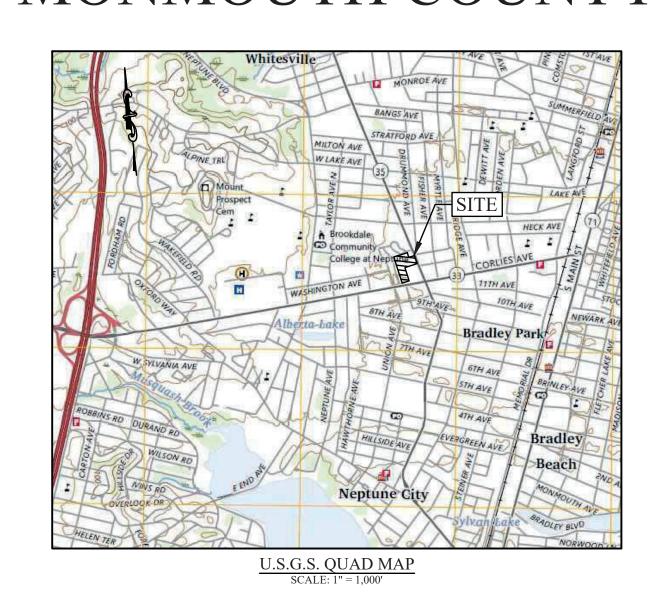

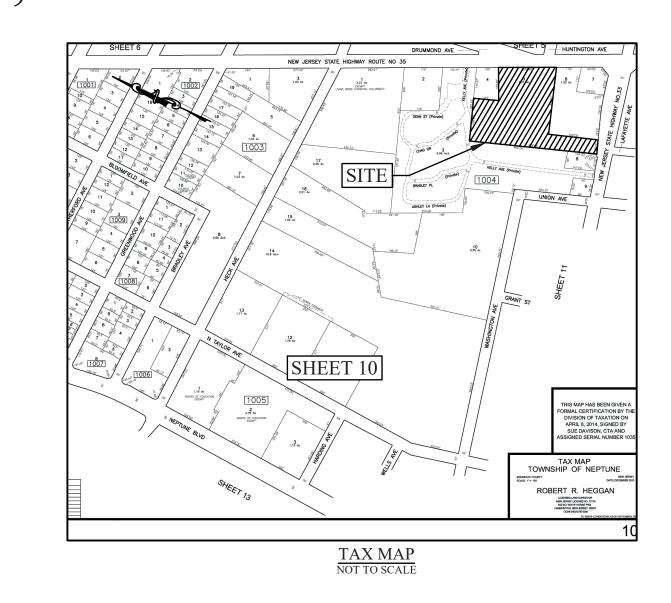

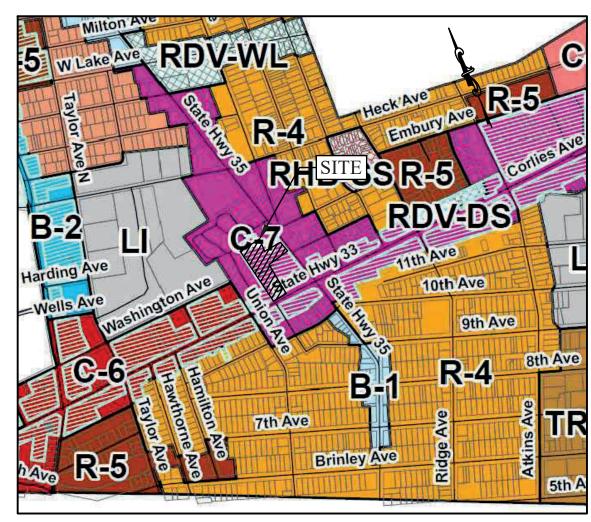

ZONING MAP
NOT TO SCALE

PREPARED FOR:

HARBOR FREIGHT TOOLS 26677 AGOURA ROAD CALABASAS, CA 91302

PREPARED BY:



497 Center Street • Sewell, NJ 08080 Tel: 856-464-9600 Fax: 856-464-9606 www.pettitgroup.com

ZONE DISTRICT: C-7 - ROUTE 35 COMMERCIAL	REQUIRED and/or PERMITTED	EXISTING	PROPOSEI
Minimum lot area (SF)	15,000	130,974	130,97
Maximum floor area ratio (FAR)	0.6	0.12	0.1
Minimum lot width (FT)	100	381.31	381.3
Minimum lot frontage (FT)	100	262.96	262.9
Minimum lot depth (FT)	100	597.26	597.2
Minimum front yard setback (FT)	15	149.4	149.
Minimum side yard setback (FT)	0/10	25.2	25.
Minimum combined side yard setback (FT)	25	156.4	156.
Minimum rear yard setback (FT)	20	35.9	35.
Maximum percent building cover (%)	35	12	1
Maximum percent lot cover (%)	80	79	7
Maximum number of stories	3	1	
Maximum building height (FT)	48	19.5	19.
Minimum improvable area (SF)	7,200	27,501	27,50
Minimum improvable area – diameter of a circle (feet)	55	80	8
Off-street parking spaces	64 (1 SP/250 SF OF GFA)	131	13
Loading spaces	1	1	
Signs	4 (2 Type A, 2 Wall Mounted)	4	
Existing use or uses: Grocery Store			
Proposed use or uses: Tool and equipment retail store			
Existing floor area: 15,800 SF			

Proposed floor area: 15,800 SF

INDEX OF DRAWINGS

	1	OF	4	COVER	SHEET	& INDEX	OF DRA	WING
--	---	----	---	-------	-------	---------	--------	------

EX. CONDITIONS & DEMOLITION PLAN

SITE PLAN

CONSTRUCTION DETAILS

REVISIONS			
NO.	DESCRIPTION	DATE	
1	BOARD ENGINEER REVIEW	1/13/25	

FOR APPROVAL

Y APPROXIMATE. IT IS IMPORTANT TO NOTE

ONSIBLE TO REPAIR (AT HIS EXPENSE 1798-02

NOT TO SCALE

MINOR SITE PLAN **15 ROUTE 35 PLATE 10, BLOCK 1004, LOT 5** (DECEMBER 2013) NEPTUNE TOWNSHIP **MONMOUTH COUNTY**

NEW JERSEY


CALABASAS, CA 91302

HARBOR FREIGHT TOOLS 26677 AGOURA ROAD




JAMES L. CURRAN, PE

COVER SHEET

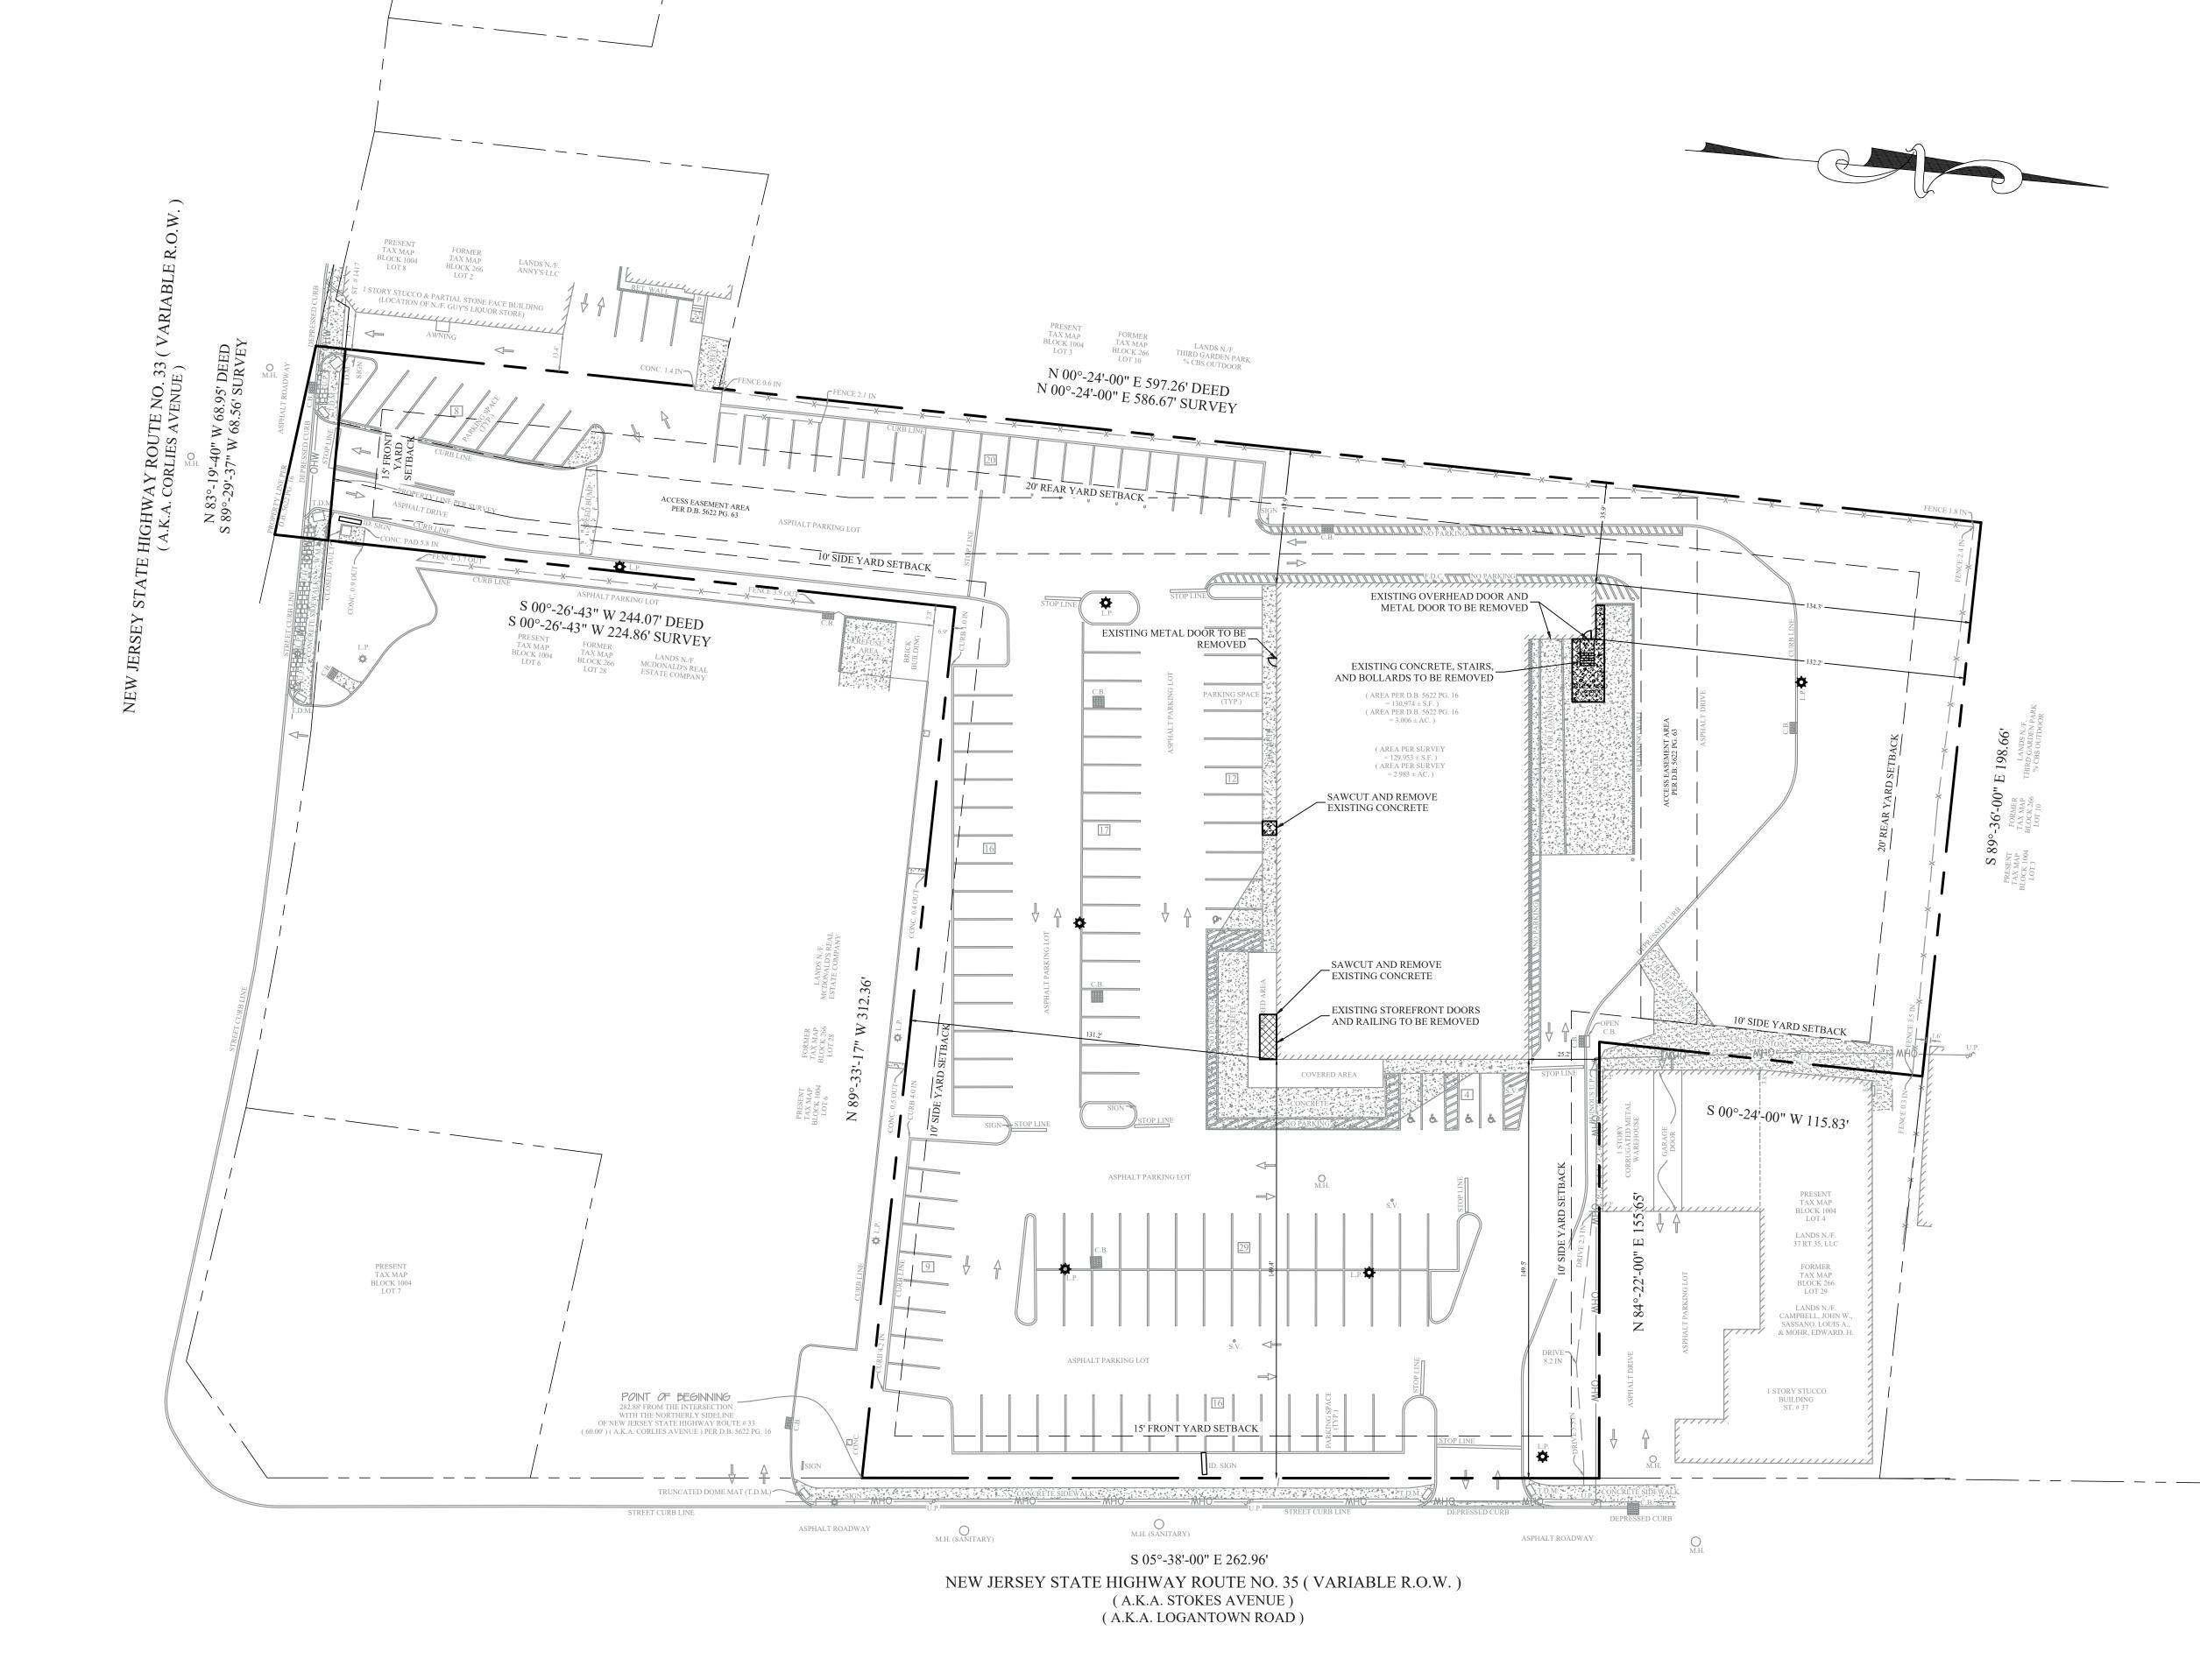

DEMOLITION & STRUCTURAL FILL NOTES:

- 1. IF PROVIDED, THE LOCATION OF EXISTING UTILITIES SHOWN ON THESE PLANS HAS BEEN TAKEN FROM VARIOUS SOURCES AND IS SHOWN FOR DESIGN AND ESTIMATING PURPOSES ONLY. ACTUAL LOCATIONS OF UTILITIES SHALL BE FIELD VERIFIED BY CONTRACTOR. ANY DISCREPANCIES OR APPARENT CONFLICTS SHALL BE CALLED TO THE ATTENTION OF THE ENGINEER FOR INTERPRETATION. ANY/ALL DISCREPANCIES SHALL BE REPORTED TO ENGINEER IN WRITING PRIOR TO ANY CONSTRUCTION. CONTRACTOR IS RESPONSIBLE FOR FIELD VERIFYING ALL EXISTING SITE IMPROVEMENTS & UTILITIES. A WRITTEN NOTICE SHALL BE FORWARDED TO THE OWNER SETTING FORTH THE DATE OF CONTACT. CONTRACTORS ARE ADVISED TO CALL 1-800-272-1000 BEFORE COMMENCING FOR A MARKOUT OF EXISTING UTILITIES.
- 2. CONTRACTOR SHALL REVIEW ALL PLAN SHEETS TO DETERMINE IF THE EXTENT OF IMPROVEMENTS TO BE REMOVED, AS INDICATED ON THIS PLAN, IS CORRECT. ANY DISCREPANCIES SHALL BE BROUGHT TO THE ATTENTION OF THE DESIGN ENGINEER DURING THE BID PHASE.
- 3. CONTRACTOR TO NOTIFY ALL UTILITY COMPANIES PRIOR TO DEMOLITION.
- 4. CONTRACTOR TO COORDINATE ALL UTILITY REMOVAL(S) AND SHUT-OFF(S). (TYPICAL)
- 5. CONTRACTOR TO COORDINATE WITH ALL APPLICABLE AGENCIES DURING THE DEMOLITION OF EXISTING BUILDINGS, IF NOTED TO BE REMOVED.
- 6. TEST PITS SHALL BE EXCAVATED PRIOR TO CONSTRUCTION TO LOCATE UNDERGROUND UTILITIES.
- 7. ANY REQUIRED UTILITY POLE RELOCATIONS FOR THE PROPOSED IMPROVEMENTS SHALL BE COMPLETED AT NO EXTRA COST TO THE OWNER. CONTRACTOR SHALL PROVIDE ALL NECESSARY ARRANGEMENTS FOR UTILITY POLE RELOCATION.
- 8. THE CONTRACTORS ARE ADVISED THAT ANY REQUIRED UNDERGROUND UTILITY RELOCATIONS INCLUDING GAS MAINS AND SERVICES, WATER MAINS AND SERVICES, SEWER MAINS AND SERVICES, ELECTRIC AND TELEPHONE LINES SHALL BE COMPLETED AT NO COST TO THE OWNER UNLESS SPECIFICALLY NOTED OTHERWISE.
- 9. EXISTING UTILITIES INCLUDING VALVE BOXES, CLEAN OUTS, CURB STOPS, MANHOLES, ETC., SHALL BE ADJUSTED TO MATCH PROPOSED FINISHED GRADE. STORM DRAINAGE STRUCTURES SHALL NOT BE ADJUSTED UNLESS SPECIFICALLY CALLED FOR. NO TRENCHES SHALL REMAIN OPEN OVERNIGHT.
- 10. SUPPORT AND STABILIZATION OF REMAINING STRUCTURES SHALL CONFORM TO THE MOST RECENT VERSION OF THE IBC ADOPTED BY THE MUNICIPALITY.
- 11. ALL DEMOLITION TO BE PERFORMED IN STRICT ADHERENCE TO ALL FEDERAL, STATE, AND LOCAL REGULATIONS.
- 12. NO DISTURBANCES SHALL BE PERMITTED BEYOND THE PROJECT PROPERTY LINE WITHOUT THE WRITTEN PERMISSION OF THE PROPERTY OWNER(S) DIRECTLY AFFECTED.
- 13. CONTRACTOR SHALL CLEAN ADJACENT STRUCTURES AFFECTED BY DEMOLITION, CONTRACTOR TO RETURN ADJACENT AREAS TO CONDITIONS EXISTING PRIOR TO START OF WORK.
- 14. THE CONTRACTOR SHALL PROPERLY DISPOSE OF SPOILS AND EXCAVATED MATERIALS. NO CONSTRUCTION DEBRIS, CUT VEGETATION, TREE STUMPS, OR ANY OTHER SOLID WASTE EXISTING ON SITE IS TO BE BURIED ON SITE. NO ON SITE BURIAL OR BURNING OF CONSTRUCTION DEBRIS IS PERMITTED. ALL WASTE MUST BE PROPERLY REMOVED AND DISPOSED OFF SITE. ALL MATERIALS REMOVED FROM SITE ARE TO BE DISPOSED OF AT AN APPROVED FACILITY.
- 15. EXISTING TOPSOIL ONSITE IS TO BE PROTECTED. NO TOPSOIL IS TO BE SOLD OR REMOVED FROM THE SITE OR USED AS SPOIL UNLESS APPLICATION IS MADE TO THE APPROVING AUTHORITY AND APPROVAL IS GRANTED.
- 16. PROJECT SITE TO BE CLEARED ONLY AS REQUIRED. EXISTING TREES SHALL BE PROTECTED ALONG WITH ALL EXCAVATION AND CONSTRUCTION LIMITS.
- 17. REMOVAL OF HAZARDOUS AND COMBUSTIBLE MATERIAL SHALL BE ACCOMPLISHED IN ACCORDANCE WITH THE PROCEDURES AS AUTHORIZED BY THE FIRE DEPARTMENT OR OTHER APPROPRIATE REGULATORY AGENCIES AND AUTHORITIES.
- 18. IF STRUCTURES ARE INDICATED TO BE REMOVED, THE CONTRACTOR SHALL DISCONNECT, SHUT OFF AND SEAL IN CONCRETE ALL UTILITIES SERVING THE STRUCTURE(S) BEFORE THE COMMENCEMENT OF DESIGNATED DEMOLITION. CLEARLY IDENTIFY, BEFORE THE COMMENCEMENT OF DESIGNATED DEMOLITION, THE REQUIRED INTERRUPTION OF ACTIVE SYSTEMS THAT MAY AFFECT OTHER PARTIES, AND NOTIFY APPLICABLE UTILITY COMPANIES TO ENSURE CONTINUATION OF SERVICE.
- 19. IF PRESENT ON-SITE, EXISTING WELLS SHALL BE ABANDONED BY A CERTIFIED WELL DRILLER, IN ACCORDANCE WITH ALL LOCAL, COUNTY, OR STATE REGULATIONS. EXISTING SEPTIC SYSTEMS SHALL BE ABANDONED IN ACCORDANCE WITH ALL LOCAL, COUNTY, OR STATE REGULATIONS.
- 20. THE CONTRACTOR SHALL BE RESPONSIBLE FOR DISCONNECTION OF ALL UTILITIES TO BE REMOVED. ALL EXISTING UTILITIES SHALL BE REMOVED BY CONTRACTOR IN ACCORDANCE WITH LOCAL MUNICIPAL & MUA SPECIFICATIONS.
- 21. IF NOTED TO BE REMOVED, EXISTING BUILDING SHALL BE DEMOLISHED INCLUDING ALL BASEMENT FOOTINGS AND FOUNDATION WALLS & MATERIALS. (BASEMENT MATERIAL SHALL BE REMOVED FROM SITE AND NOT USED FOR FILL).
- 22. THE ON-SITE SOILS WHICH ARE EXCAVATED FOR SITE GRADING MAY BE USED AS STRUCTURAL FILL FOR SUPPORT OF SLAB-ON-GRADE AND PAVEMENT. HOWEVER, THESE SOILS CONTAIN AN APPRECIABLE AMOUNT OF FINES AND WILL BE MOISTURE SENSITIVE. THEREFORE, USAGE OF THE ON-SITE SOIL WILL BE LIMITED TO PERIODS OF WARM AND/OR DRY WEATHER. IF OFF-SITE MATERIALS ARE REQUIRED FOR FILL, CRUSHED STONE OR RECYCLED CRUSHED CONCRETE MEETING THE MINIMUM REQUIREMENTS OF NJDOT COURSE AGGREGATE NO. 2 SHOULD BE USED.
- 23. STRUCTURAL FILL SHOULD BE PLACED IN HORIZONTAL LIFTS NOT MORE THAN 6 INCHES IN LOOSE THICKNESS. WITHIN THE BUILDING AREA, THE FILL SHOULD BE COMPACTED TO AT LEAST 95 PERCENT OF THE MAXIMUM DRY DENSITY DETERMINED BY THE "MODIFIED PROCTOR" COMPACTION TEST, ASTM D 1557. ALTERNATIVELY, EACH LIFT OF IMPORTED CRUSHED STONE SHOULD BE COMPACTED TO AT LEAST 85 PERCENT RELATIVE DENSITY AS DETERMINED BY ASTM D 4253 / 4254, OR THE US ARMY CORPS OF ENGINEERS MODIFIED PROVIDENCE VIBRATED DENSITY TEST. THE RELATIVE DENSITY METHOD IS USED FOR FREE-DRAINING SOILS WHICH TO NOT EXHIBIT A WELL-DRAINED PEAK IN THE PROCTOR TEST, OR WHICH BREAK DOWN EXCESSIVELY UNDER THE TEST RAMMER. STRUCTURAL FILL SHOULD BE COMPACTED USING A SELF-PROPELLED, VIBRATORY ROLLER WHICH IMPARTS A TOTAL DYNAMIC FORCE OF AT LEAST 300 POUNDS PER INCH OF DRUM LENGTH. IN CONFINED AREAS, WHERE SMALLER ROLLERS OR MANUALLY OPERATED TAMPERS ARE USED, THE LIFT THICKNESS SHOULD BE REDUCED TO 6 INCHES.
- 24. BACKFILL AROUND THE EXTERIOR OF THE BUILDING, AND FILL IN PAVEMENT AREAS SHOULD BE COMPACTED TO AT LEAST 90 PERCENT OF THE MODIFIED PROCTOR MAXIMUM DRY DENSITY. ON-SITE SOIL MAY BE USED FOR EXTERIOR BACKFILL.

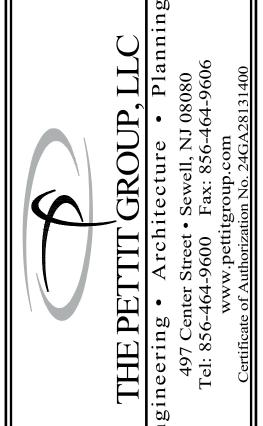

KE VISIONS				
NO.	DESCRIPTION	DATE		
1	BOARD ENGINEER REVIEW	1/13/25		

REVISIONS

FOR APPROVAL PURPOSES ONLY

ALL DOCUMENTS PREPARED BY THE PETTIT GROUP, LLA ARE INSTRUMENTS OF SERVICE IN RESPECT TO THE PROJECT. THEY ARE NOT INTENDED OR REPRESENTED TO BE SUITABLE FOR REUSE BY OWNER OR OTHERS OF EXTENSIONS OF THE PROJECT OR ANY OTHER PROJECT ANY REUSE WITHOUT WRITTEN PERMISSION BY THE PETTIT GROUP, LLC FOR THE SPECIFIC PURPOSI INTENDED WILL BE AT THE OWNERS SOLE RISK AND WITHOUT LIABILITY OR LEGAL EXPOSURE TO THE PETTIT GROUP, LLC AND OWNER SHALL INDEMNIFF AND HOLD HARMLESS THE PETTIT GROUP, LLC FROM CLAIMS, DAMAGES, LOSSES AND EXPENSES ARISING OUT OF OR RESULTING THEREFROM.

IE CONTRACTOR MUST VERIFY ALL DIMENS

OWNER OF ANY DISCREPANCIES.

LOCATION OF UTILITIES SHOWN ON THE PLANS ARE ONLY APPROXIMATE. IT IS IMPORTANT TO NOTE THAT NOT ALL UTILITIES MAY BE SHOWN ON THE PLANS. IT IS THE RESPONSIBILITY OF THE CONTRACTOR TO LOCATE ALL UTILITIES (AERIAL AND BURIED) PRIOR TO THE START OF CONSTRUCTION. THE CONTRACTOR IS RESPONSIBLE TO CONTACT THE UNDERGROUND UTILITY MARK OUT SERVICE (1-800-272-1000) PRIOR TO THE START OF CONSTRUCTION. THE CONTRACTOR IS RESPONSIBLE TO REPAIR (AT HIS EXPENSE) ALL DAMAGED UTILITIES RESULTING FROM HIS WORK.

NAK	1798-02
DRAWN BY: NAK	DATE: 04-30-24
CHECKED BY: JLC	SCALE: 1' = 30'

MINOR SITE PLAN
15 ROUTE 35
PLATE 10, BLOCK 1004, LOT 5
(DECEMBER 2013)
NEPTUNE TOWNSHIP
MONMOUTH COUNTY

NEW JERSEY FOR


HARBOR FREIGHT TOOLS 26677 AGOURA ROAD CALABASAS, CA 91302



Professional Engineer
State of New Jersey • License # GE 42231
State of Pennsylvania • License # 054474E
State of Delaware • License # 14560

EX. CONDITIONS & DEMO PLAN

2 of 4

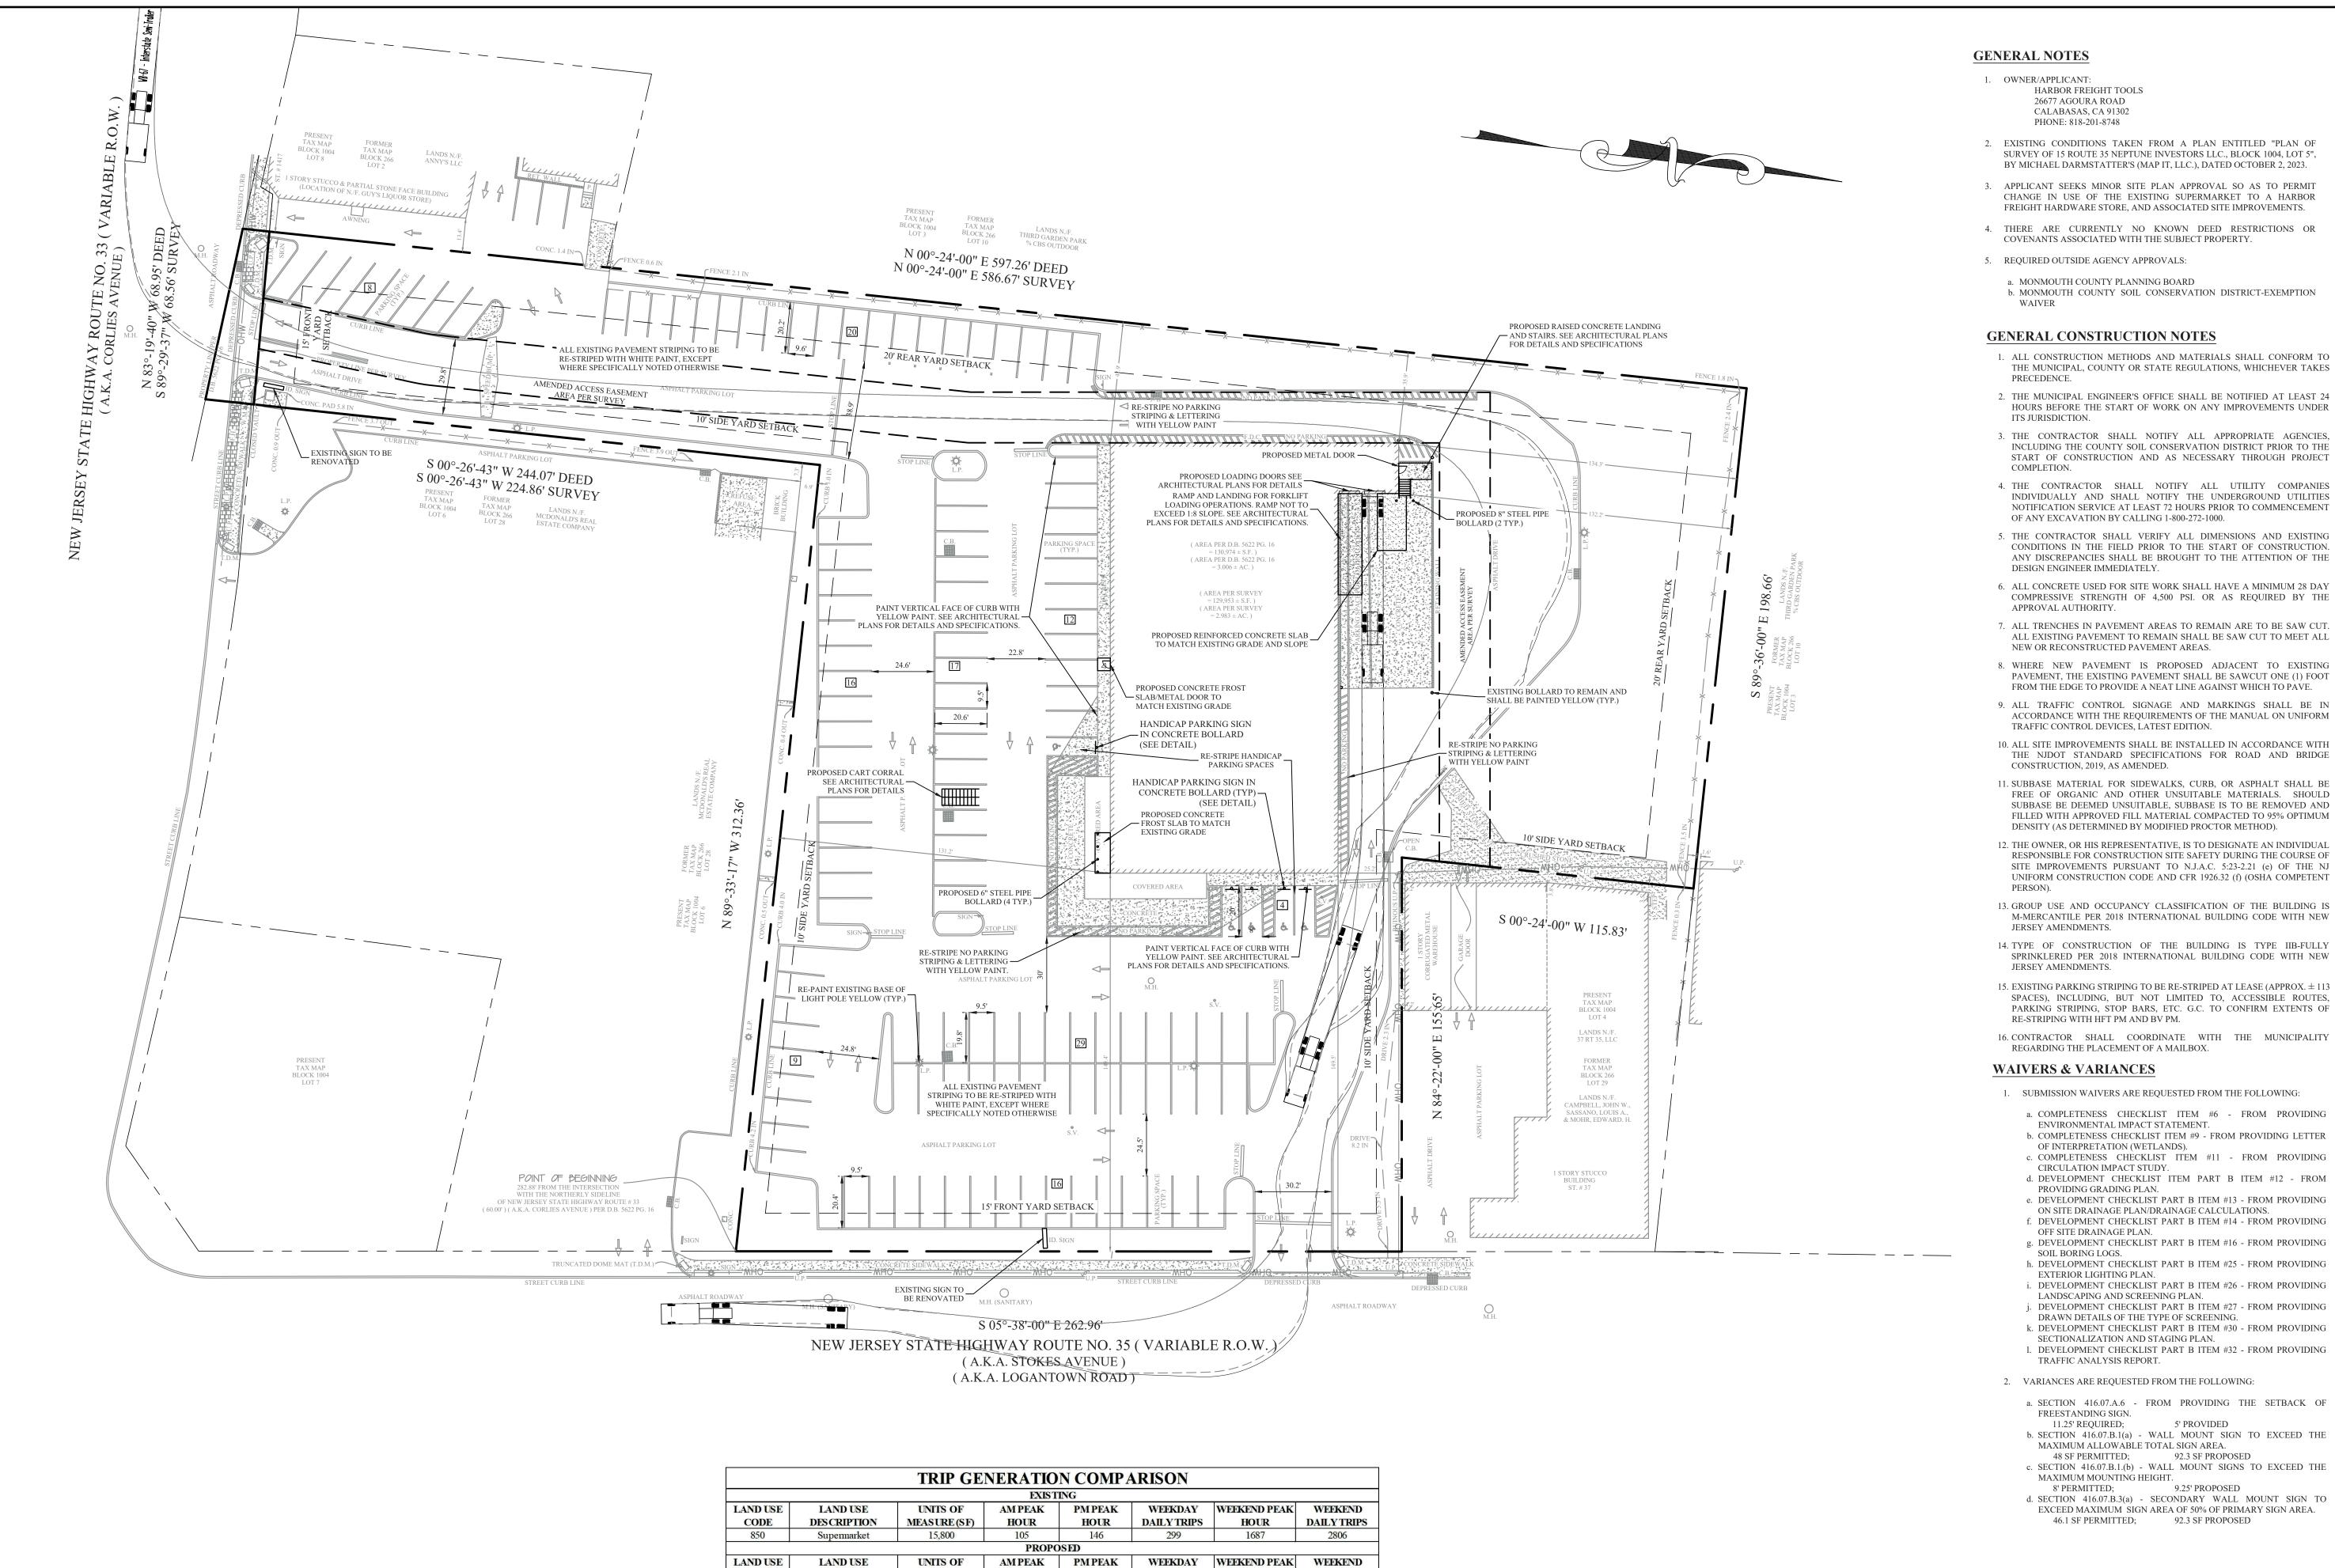

HOUR DAILY TRIPS

HOUR

DESCRIPTION

MEASURE (X)

15,800

HOUR

GENERAL NOTES

- OWNER/APPLICANT: HARBOR FREIGHT TOOLS 26677 AGOURA ROAD CALABASAS, CA 91302 PHONE: 818-201-8748
- 2. EXISTING CONDITIONS TAKEN FROM A PLAN ENTITLED "PLAN OF SURVEY OF 15 ROUTE 35 NEPTUNE INVESTORS LLC., BLOCK 1004, LOT 5", BY MICHAEL DARMSTATTER'S (MAP IT, LLC.), DATED OCTOBER 2, 2023.
- 3. APPLICANT SEEKS MINOR SITE PLAN APPROVAL SO AS TO PERMIT CHANGE IN USE OF THE EXISTING SUPERMARKET TO A HARBOR FREIGHT HARDWARE STORE, AND ASSOCIATED SITE IMPROVEMENTS.
- 4. THERE ARE CURRENTLY NO KNOWN DEED RESTRICTIONS OR COVENANTS ASSOCIATED WITH THE SUBJECT PROPERTY.
- 5. REQUIRED OUTSIDE AGENCY APPROVALS:
- a. MONMOUTH COUNTY PLANNING BOARD
- b. MONMOUTH COUNTY SOIL CONSERVATION DISTRICT-EXEMPTION WAIVER

GENERAL CONSTRUCTION NOTES

- 1. ALL CONSTRUCTION METHODS AND MATERIALS SHALL CONFORM TO THE MUNICIPAL, COUNTY OR STATE REGULATIONS, WHICHEVER TAKES PRECEDENCE.
- 2. THE MUNICIPAL ENGINEER'S OFFICE SHALL BE NOTIFIED AT LEAST 24 HOURS BEFORE THE START OF WORK ON ANY IMPROVEMENTS UNDER ITS JURISDICTION.
- 3. THE CONTRACTOR SHALL NOTIFY ALL APPROPRIATE AGENCIES, INCLUDING THE COUNTY SOIL CONSERVATION DISTRICT PRIOR TO THE START OF CONSTRUCTION AND AS NECESSARY THROUGH PROJECT COMPLETION.
- 4. THE CONTRACTOR SHALL NOTIFY ALL UTILITY COMPANIES INDIVIDUALLY AND SHALL NOTIFY THE UNDERGROUND UTILITIES NOTIFICATION SERVICE AT LEAST 72 HOURS PRIOR TO COMMENCEMENT OF ANY EXCAVATION BY CALLING 1-800-272-1000.
- 5. THE CONTRACTOR SHALL VERIFY ALL DIMENSIONS AND EXISTING CONDITIONS IN THE FIELD PRIOR TO THE START OF CONSTRUCTION. ANY DISCREPANCIES SHALL BE BROUGHT TO THE ATTENTION OF THE DESIGN ENGINEER IMMEDIATELY.
- COMPRESSIVE STRENGTH OF 4,500 PSI. OR AS REQUIRED BY THE APPROVAL AUTHORITY.
- 7. ALL TRENCHES IN PAVEMENT AREAS TO REMAIN ARE TO BE SAW CUT. ALL EXISTING PAVEMENT TO REMAIN SHALL BE SAW CUT TO MEET ALL NEW OR RECONSTRUCTED PAVEMENT AREAS.
- 8. WHERE NEW PAVEMENT IS PROPOSED ADJACENT TO EXISTING PAVEMENT, THE EXISTING PAVEMENT SHALL BE SAWCUT ONE (1) FOOT FROM THE EDGE TO PROVIDE A NEAT LINE AGAINST WHICH TO PAVE.
- ACCORDANCE WITH THE REQUIREMENTS OF THE MANUAL ON UNIFORM TRAFFIC CONTROL DEVICES, LATEST EDITION. 10. ALL SITE IMPROVEMENTS SHALL BE INSTALLED IN ACCORDANCE WITH
- THE NJDOT STANDARD SPECIFICATIONS FOR ROAD AND BRIDGE CONSTRUCTION, 2019, AS AMENDED.
- 11. SUBBASE MATERIAL FOR SIDEWALKS, CURB, OR ASPHALT SHALL BE FREE OF ORGANIC AND OTHER UNSUITABLE MATERIALS. SHOULD SUBBASE BE DEEMED UNSUITABLE, SUBBASE IS TO BE REMOVED AND FILLED WITH APPROVED FILL MATERIAL COMPACTED TO 95% OPTIMUM DENSITY (AS DETERMINED BY MODIFIED PROCTOR METHOD).
- 12. THE OWNER, OR HIS REPRESENTATIVE, IS TO DESIGNATE AN INDIVIDUAL RESPONSIBLE FOR CONSTRUCTION SITE SAFETY DURING THE COURSE OF SITE IMPROVEMENTS PURSUANT TO N.J.A.C. 5:23-2.21 (e) OF THE NJ UNIFORM CONSTRUCTION CODE AND CFR 1926.32 (f) (OSHA COMPETENT
- 13. GROUP USE AND OCCUPANCY CLASSIFICATION OF THE BUILDING IS M-MERCANTILE PER 2018 INTERNATIONAL BUILDING CODE WITH NEW JERSEY AMENDMENTS.
- 14. TYPE OF CONSTRUCTION OF THE BUILDING IS TYPE IIB-FULLY SPRINKLERED PER 2018 INTERNATIONAL BUILDING CODE WITH NEW JERSEY AMENDMENTS.
- 15. EXISTING PARKING STRIPING TO BE RE-STRIPED AT LEASE (APPROX. \pm 113 SPACES), INCLUDING, BUT NOT LIMITED TO, ACCESSIBLE ROUTES, PARKING STRIPING, STOP BARS, ETC. G.C. TO CONFIRM EXTENTS OF RE-STRIPING WITH HFT PM AND BV PM.
- 16. CONTRACTOR SHALL COORDINATE WITH THE MUNICIPALITY

WAIVERS & VARIANCES

- 1. SUBMISSION WAIVERS ARE REQUESTED FROM THE FOLLOWING:
 - a. COMPLETENESS CHECKLIST ITEM #6 FROM PROVIDING ENVIRONMENTAL IMPACT STATEMENT.
- b. COMPLETENESS CHECKLIST ITEM #9 FROM PROVIDING LETTER OF INTERPRETATION (WETLANDS).
- c. COMPLETENESS CHECKLIST ITEM #11 FROM PROVIDING CIRCULATION IMPACT STUDY. d. DEVELOPMENT CHECKLIST ITEM PART B ITEM #12 - FROM
- PROVIDING GRADING PLAN. e. DEVELOPMENT CHECKLIST PART B ITEM #13 - FROM PROVIDING
- ON SITE DRAINAGE PLAN/DRAINAGE CALCULATIONS. f. DEVELOPMENT CHECKLIST PART B ITEM #14 - FROM PROVIDING OFF SITE DRAINAGE PLAN.
- g. DEVELOPMENT CHECKLIST PART B ITEM #16 FROM PROVIDING SOIL BORING LOGS.
- h. DEVELOPMENT CHECKLIST PART B ITEM #25 FROM PROVIDING EXTERIOR LIGHTING PLAN.
- i. DEVELOPMENT CHECKLIST PART B ITEM #26 FROM PROVIDING LANDSCAPING AND SCREENING PLAN.
- j. DEVELOPMENT CHECKLIST PART B ITEM #27 FROM PROVIDING DRAWN DETAILS OF THE TYPE OF SCREENING.
- k. DEVELOPMENT CHECKLIST PART B ITEM #30 FROM PROVIDING SECTIONALIZATION AND STAGING PLAN.
- 1. DEVELOPMENT CHECKLIST PART B ITEM #32 FROM PROVIDING TRAFFIC ANALYSIS REPORT.
- 2. VARIANCES ARE REQUESTED FROM THE FOLLOWING:
- a. SECTION 416.07.A.6 FROM PROVIDING THE SETBACK OF FREESTANDING SIGN.
- 11.25' REQUIRED; b. SECTION 416.07.B.1(a) - WALL MOUNT SIGN TO EXCEED THE MAXIMUM ALLOWABLE TOTAL SIGN AREA.
- 48 SF PERMITTED; c. SECTION 416.07.B.1.(b) - WALL MOUNT SIGNS TO EXCEED THE
- MAXIMUM MOUNTING HEIGHT.
- 8' PERMITTED; 9.25' PROPOSED d. SECTION 416.07.B.3(a) - SECONDARY WALL MOUNT SIGN TO EXCEED MAXIMUM SIGN AREA OF 50% OF PRIMARY SIGN AREA. 46.1 SF PERMITTED; 92.3 SF PROPOSED

	REVISIONS				
NO.	DESCRIPTION	DATE			
1	BOARD ENGINEER REVIEW	1/13/25			

FOR APPROVAL **PURPOSES ONLY**

OJECT. THEY ARE NOT INTENDED OR REPRESE O BE SUITABLE FOR REUSE BY OWNER OR OTHERS EXTENSIONS OF THE PROJECT OR ANY OTHER PROJE NY REUSE WITHOUT WRITTEN PERMISSION BY TTIT GROUP, LLC FOR THE SPECIFIC PURPOS TENDED WILL BE AT THE OWNERS SOLE RISK AN ND HOLD HARMLESS THE PETTIT GROUP, LLC FROM HE CONTRACTOR MUST VERIFY ALL DIMEN OWNER OF ANY DISCREPANCIES.

JLY APPROXIMATE. IT IS IMPORTANT TO NOTE T ALL UTILITIES MAY BE SHOWN ON THE PLANS. I E RESPONSIBILITY OF THE CONTRACTOR TO LOCA L UTILITIES (AERIAL AND BURIED) PRIOR TO THAT OF CONSTRUCTION. THE CONTRACTOR SPONSIBLE TO CONTACT THE UNDERGROUN ILITY MARK OUT SERVICE (1-800-272-1000) PRIOR E START OF CONSTRUCTION. THE CONTRACTOR ONSIBLE TO REPAIR (AT HIS EXPENSE)
AGED UTILITIES RESULTING FROM HIS WORK.

DESIGNED BY:	JOB NO:
NAK	1798-02
DRAWN BY: NAK	DATE: 04-30-24
CHECKED BY:	SCALE:
JLC	1' = 30'

MINOR SITE PLAN **15 ROUTE 35 PLATE 10, BLOCK 1004, LOT 5** (DECEMBER 2013) NEPTUNE TOWNSHIP **MONMOUTH COUNTY**

> **NEW JERSEY FOR**


HARBOR FREIGHT TOOLS 26677 AGOURA ROAD CALABASAS, CA 91302




JAMES L. CURRAN, PE Professional Engineer
State of New Jersey • License # GE 42231 State of Pennsylvania • License # 054474E

State of Delaware • License # 14560

SITE PLAN

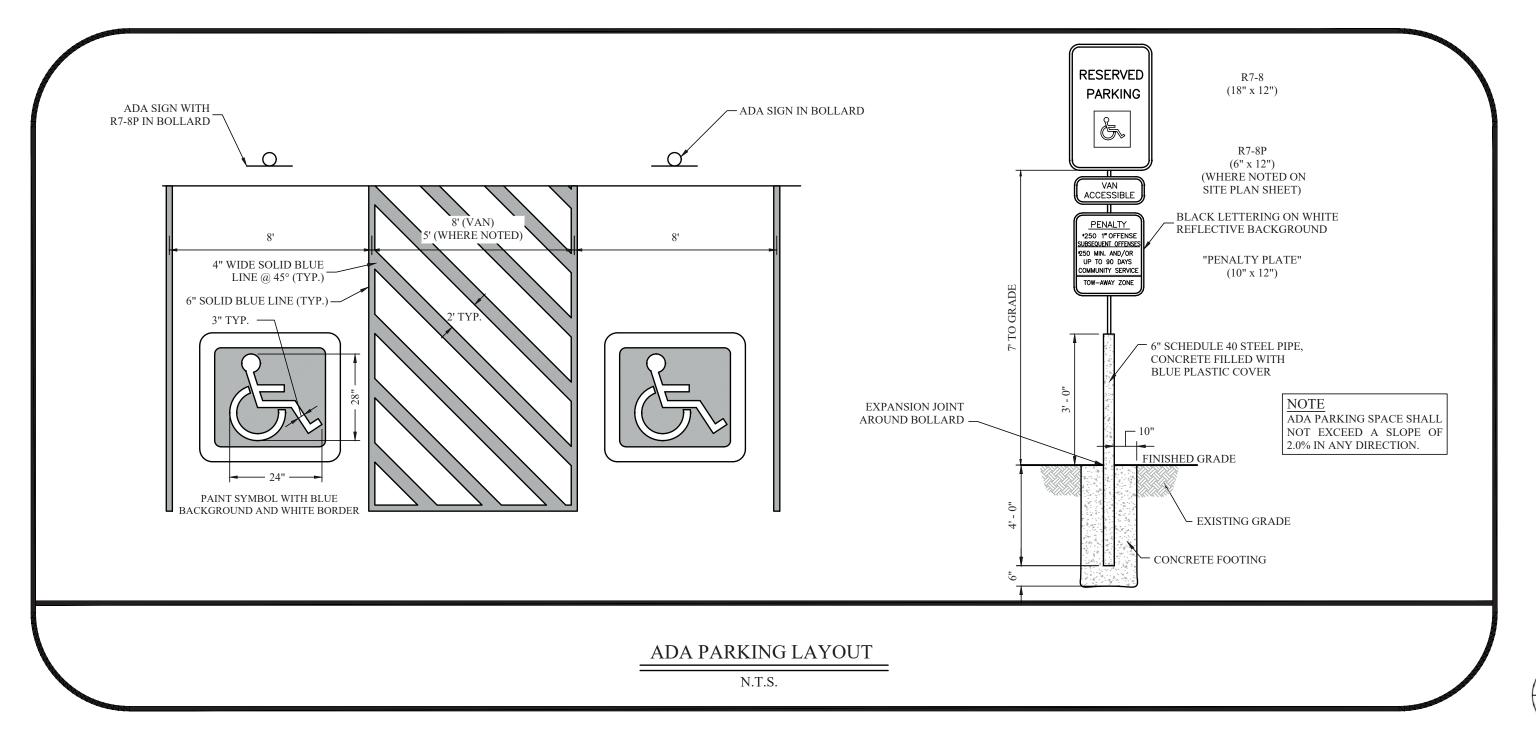

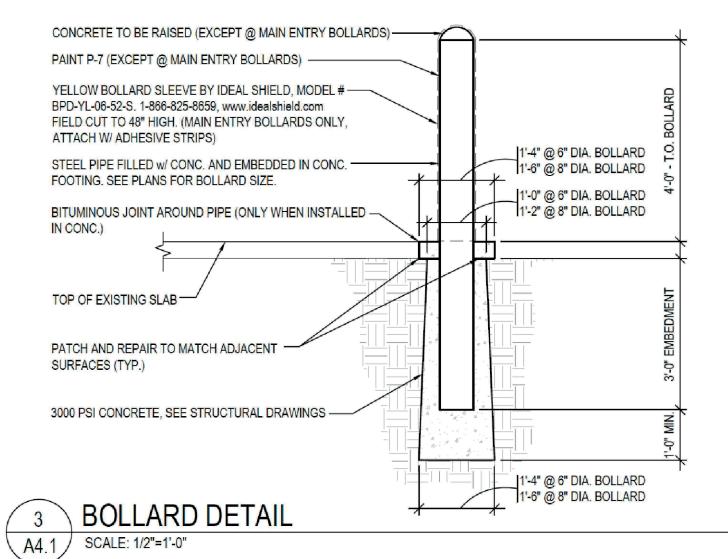


T.O. FLOOR LINE OF EXISTING EXTERIOR ---WALL BEYOND 6" THICK FIBER REINFORCED CONCRETE RECEIVING PAD. SLOPE PAD TO MEET EXISTING CONCRETE PAVEMENT TO THE EAST, SEE STRUCTURAL DRAWINGS. PROVIDE EXPANSION JOINT AND SEALANT SAWCUT CONTROL JOINTS WITH CHANGES IN SLOPE AND @ 10'-0" MAX. EACH WAY w/ 3:2 MAX ASPECT RATIO. — EXISTING CONCRETE PAVEMENT, TYP. EXPANSION JOINT AND SEALANT -└── 6" COMPACTED EXISTING WALL FOOTING AGGRAGATE COMPACTED SUBGRADE

CONCRETE SECTION

A4.2 SCALE: 1/2"=1'-0"

EXISTING CONDITIONS MAY VARY
 SLAB TO BE 4" MIN. AND SPAN A MAX OF 6'-0" OR DESIGN WILL NEED TO BE RE-ENGINEERED.
 SEE SHEET A1.1 FOR DIMENSIONS AND DEPRESSION OF SLAB.
 FOR TURNED DOWN SLAB RETURN, USE #4X18" DOWELS @ 12" O.C. VERTICALLY W/ MIN. 6" EMBED IN EXISTING STEM WALL USING APPROVED EPOXY. SEE STRUCTURAL DRAWINGS

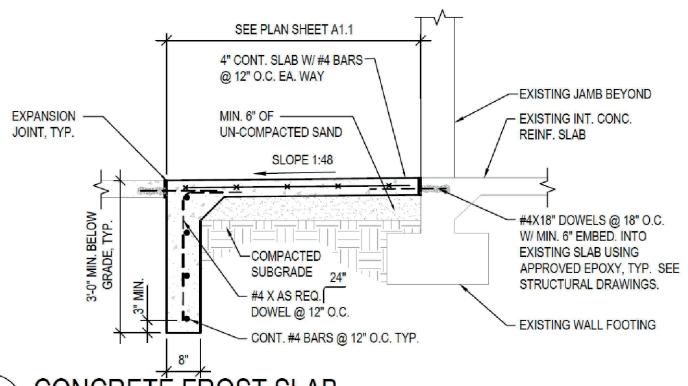

9 CONCRETÉ FROST SLAB

A4.1 SCALE: 1/2" = 1' - 0"

THE PETTIT GROUP, LLC agineering • Architecture • Plann 497 Center Street • Sewell, NJ 08080 Tel: 856-464-9600 Fax: 856-464-9606

	REVISIONS			
NO.	DESCRIPTION	DATE		
1	BOARD ENGINEER REVIEW	1/13/25		

FOR APPROVAL PURPOSES ONLY

ALL DOCUMENTS PREPARED BY THE PETTIT GROUP, LLC ARE INSTRUMENTS OF SERVICE IN RESPECT TO THE PROJECT. THEY ARE NOT INTENDED OR REPRESENTED TO BE SUITABLE FOR REUSE BY OWNER OR OTHERS ON EXTENSIONS OF THE PROJECT OR ANY OTHER PROJECT. ANY REUSE WITHOUT WRITTEN PERMISSION BY THE PETTIT GROUP, LLC FOR THE SPECIFIC PURPOSE INTENDED WILL BE AT THE OWNERS SOLE RISK AND WITHOUT LIABILITY OR LEGAL EXPOSURE TO THE PETTIT GROUP, LLC AND OWNER SHALL INDEMNIFY AND HOLD HARMLESS THE PETTIT GROUP, LLC FROM CLAIMS, DAMAGES, LOSSES AND EXPENSES ARISING OUT OF OR RESULTING THEREFROM.

THE CONTRACTOR MUST VERIFY ALL DIMENSIONS PRIOR TO PROCEEDING WITH THE WORK AND NOTIFY THE OWNER OF ANY DISCREPANCIES. THE CONTRACTOR SHALL UNDERSTAND THAT THE LOCATION OF UTILITIES SHOWN ON THE PLANS ARE ONLY APPROXIMATE. IT IS IMPORTANT TO NOTE THAT NOT ALL UTILITIES MAY BE SHOWN ON THE PLANS. IT IS THE RESPONSIBILITY OF THE CONTRACTOR TO LOCATE ALL UTILITIES (AERIAL AND BURIED) PRIOR TO THE START OF CONSTRUCTION. THE CONTRACTOR IS RESPONSIBLE TO CONTACT THE UNDERGROUND UTILITY MARK OUT SERVICE (1-800-272-1000) PRIOR TO THE START OF CONSTRUCTION. THE CONTRACTOR IS RESPONSIBLE TO REPAIR (AT HIS EXPENSE) ALL DAMAGED UTILITIES RESULTING FROM HIS WORK.

DESIGNED BY: NAK	JOB NO: 1798-02
DRAWN BY: NAK	DATE: 04-30-24
CHECKED BY: JLC	SCALE: NOT TO SCALE

MINOR SITE PLAN
15 ROUTE 35
PLATE 10, BLOCK 1004, LOT 5
(DECEMBER 2013)
NEPTUNE TOWNSHIP
MONMOUTH COUNTY

NEW JERSEY

FOR

HARBOR FREIGHT TOOLS 26677 AGOURA ROAD CALABASAS, CA 91302



JAMES L. CURRAN, PE

Professional Engineer
State of New Jersey • License # GE 42231
State of Pennsylvania • License # 054474E
State of Delaware • License # 14560

CONSTRUCTION DETAILS

 \mathbf{I} of \mathbf{Z}